
# Absolutely Positively Wellington City Council

Me Heke Ki Pōneke



## BROOKLYN HILL CYCLING IMPROVEMENTS

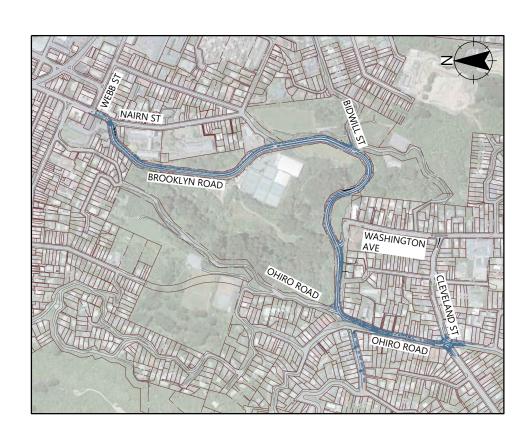


SHEET NUMBER	PRAWING TITLE
C000	COVER PAGE
C300	OVERALL GENERAL ARRANGEMENT PLAN
C301	GENERAL ARRANGEMENT PLAN SHEET 1 OF 10
C302	GENERAL ARRANGEMENT PLAN SHEET 2 OF 10
C303	GENERAL ARRANGEMENT PLAN SHEET 3 OF 10
C304	GENERAL ARRANGEMENT PLAN SHEET 4 OF 10
C305	GENERAL ARRANGEMENT PLAN SHEET 5 OF 10
C306	GENERAL ARRANGEMENT PLAN SHEET 6 OF 10
C307	GENERAL ARRANGEMENT PLAN SHEET 7 OF 10
C308	GENERAL ARRANGEMENT PLAN SHEET 8 OF 10
C309	GENERAL ARRANGEMENT PLAN SHEET 9 OF 10
C310	GENERAL ARRANGEMENT PLAN SHEET 10 OF 10
C320	VEHICLE TRACKING PLAN SHEET 1 OF 6
C321	VEHICLE TRACKING PLAN SHEET 2 OF 6
C322	VEHICLE TRACKING PLAN SHEET 3 OF 6
C323	VEHICLE TRACKING PLAN SHEET 4 OF 6
C324	VEHICLE TRACKING PLAN SHEET 5 OF 6
C325	VEHICLE TRACKING PLAN SHEET 6 OF 6
C330	SIGHT DISTANCE CHECK, KERB EXTENSION REMOVAL (21 BROOKLYN ROAD)
C331	SIGHT DISTANCE CHECK, KERB EXTENSION REMOVAL (25 BROOKLYN ROAD)
5001	
C500	TYPICAL DETAILS BUS STOP ISLAND (ID:6715)
C500	TYPICAL DETAILS BUS STOP ISLAND (ID:6716)
5501	. The Later was a second regime (also re)
C506	PEDESTRIAN CROSSING DETAILS
5500	EDESTRIAN GROSSING DETAILS
C507	STANDARD DETAILS SHEET 1 OF 6
C508	STANDARD DETAILS SHEET 2 OF 6
C509	STANDARD DETAILS SHEET 2 OF 6
C510	STANDARD DETAILS SHEET 3 OF 6 STANDARD DETAILS SHEET 4 OF 6
C511 C512	STANDARD DETAILS SHEET 5 OF 6 STANDARD DETAILS SHEET 6 OF 6
5512	STANDARD DETAILS SHEET 0 OF 0
0000	NEDAL EVICENCE OF AN
C600	OVERALL EXISTING SERVICES PLAN
C601	EXISTING SERVICES SHEET 1 OF 10
C602	EXISTING SERVICES SHEET 2 OF 10
C603	EXISTING SERVICES SHEET 3 OF 10
C604	EXISTING SERVICES SHEET 4 OF 10
C605	EXISTING SERVICES SHEET 5 OF 10
C606	EXISTING SERVICES SHEET 6 OF 10
C607	EXISTING SERVICES SHEET 7 OF 10
C608	EXISTING SERVICES SHEET 8 OF 10
C609	EXISTING SERVICES SHEET 9 OF 10
	EXISTING SERVICES SHEET 10 OF 10
C610	
	RETAINING WALL 2 OHIRO ROAD LOCALITY & SITE PLAN
S04 S05	RETAINING WALL 2 OHIRO ROAD LOCALITY & SITE PLAN RETAINING WALL 2 OHIRO ROAD SECTION B

## ISSUED FOR CONSTRUCTION

PROJECT NO.	SHEET	REVISION
BIL-1003220	C000	0

egis-group.com

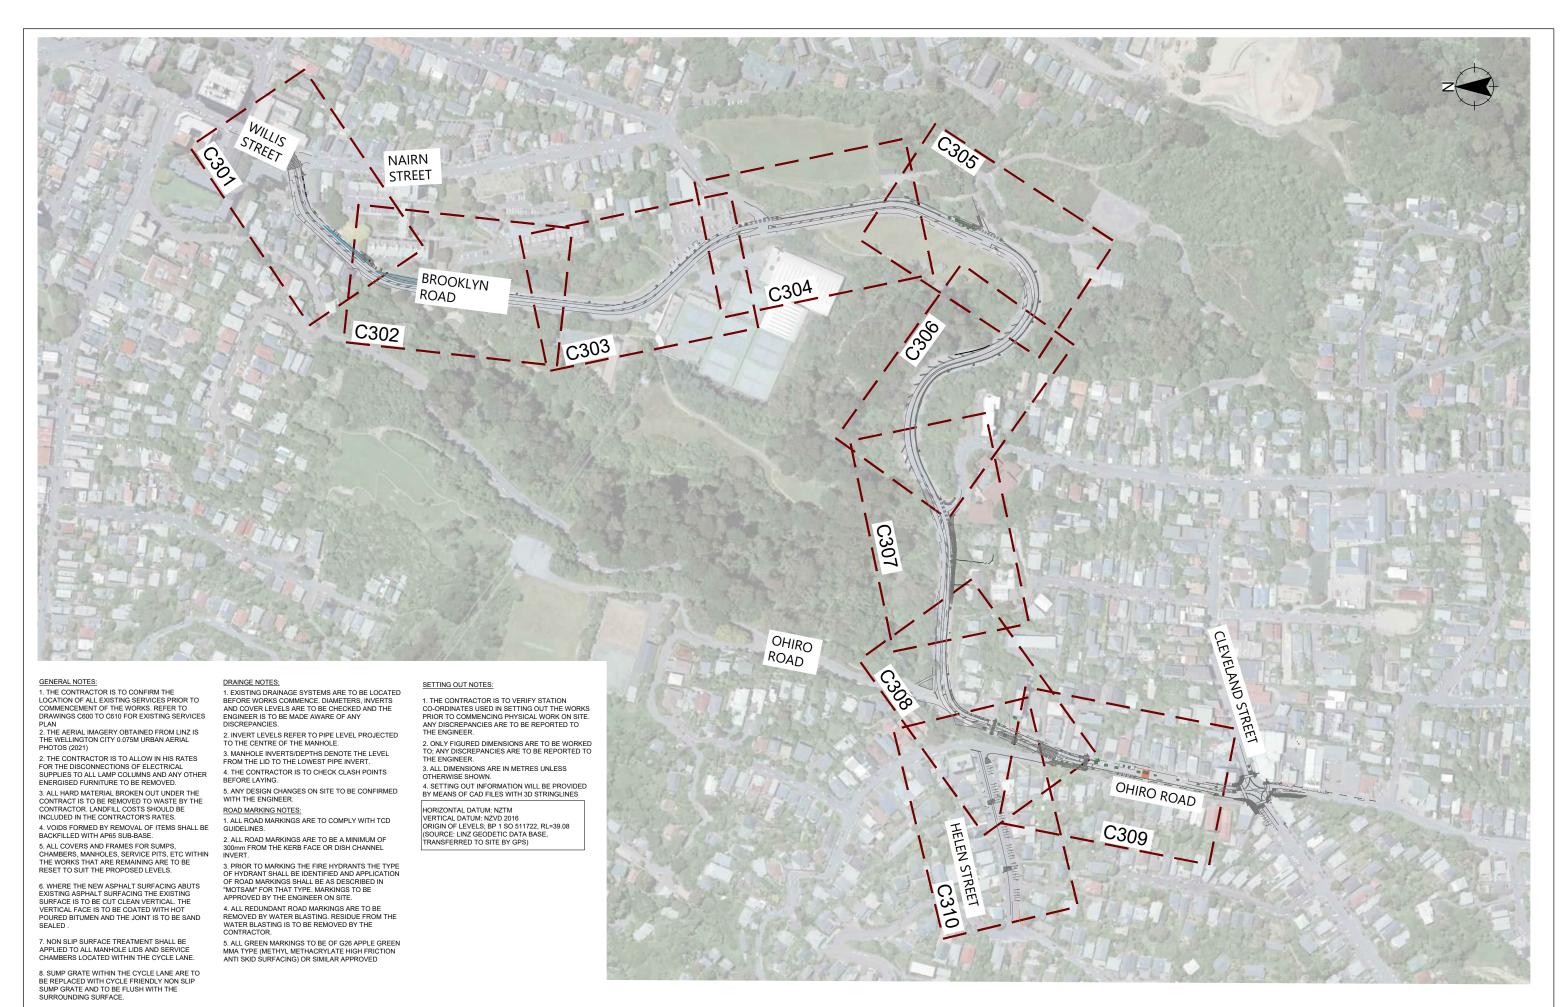

							SURVEYED	DATE
							JACOBS	01.11.2023
_							DESIGNED	DATE
							A.VERMA	17.09.2025
							DRAWN	DATE
							A.VERMA	17.09.2025
							CHECKED	DATE
_							S.CANHAM	17.09.2025
0	ISSUED FOR CONSTRUCTION	AV	AV	SC	SC	17.09.2025		
-							APPROVED	DATE
REV	AMENDMENTS	DES	DRN	CHK	APP	DATE	SCANHAM	17 09 2025



Absolutely Positively **Wellington** City Council
Me Heke Ki Pöneke


BROOKLYN HILL
CYCLING IMPROVEMENTS
THILE
OVERALL GENERAL ARRANGEMENT PLAN


ISSUED FOR CONSTRUCTION


1:1750 (A3) 1: 3500


C300


BIL-1003220

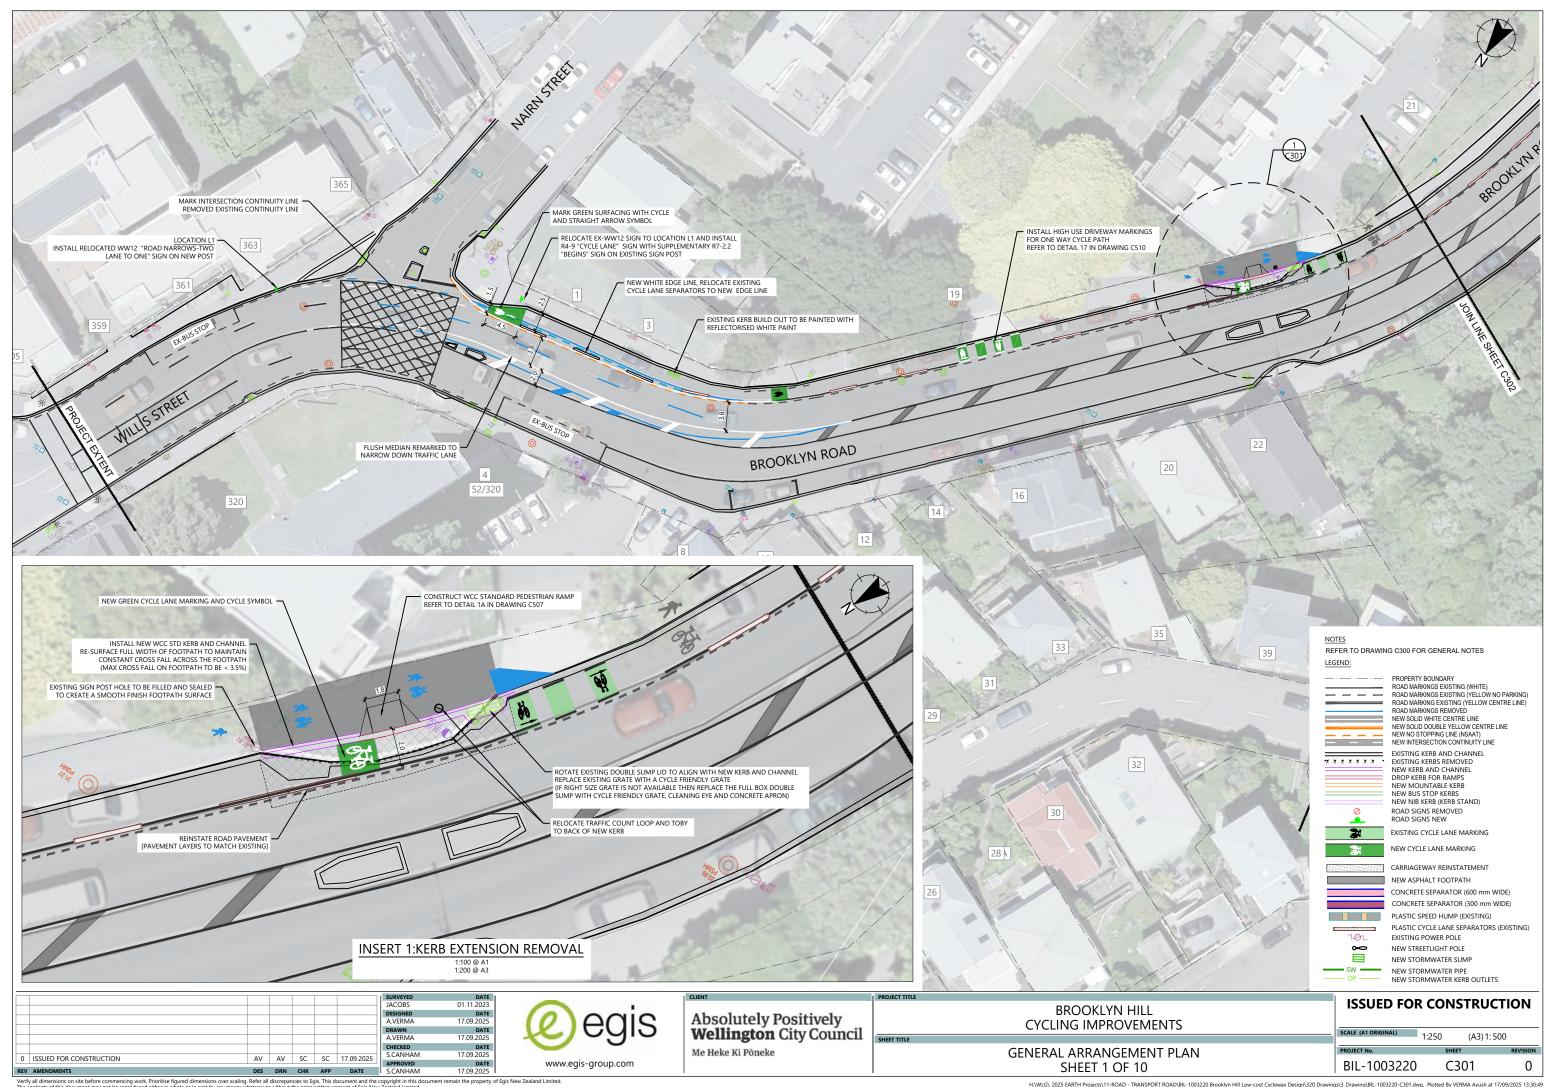


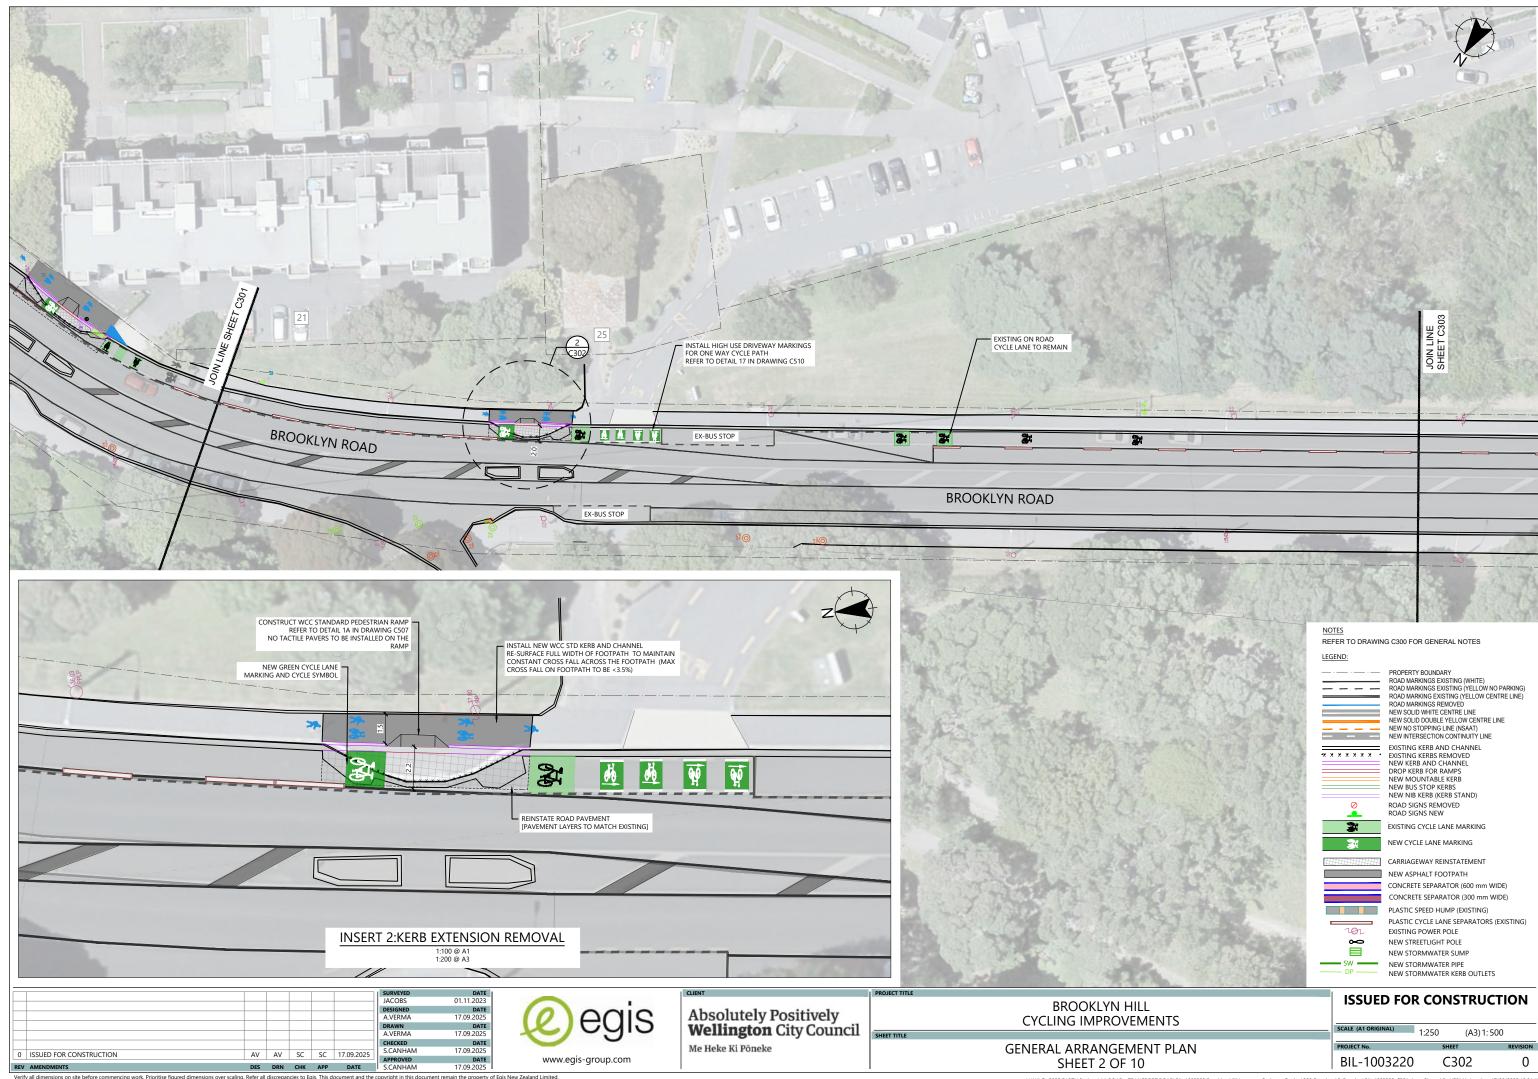


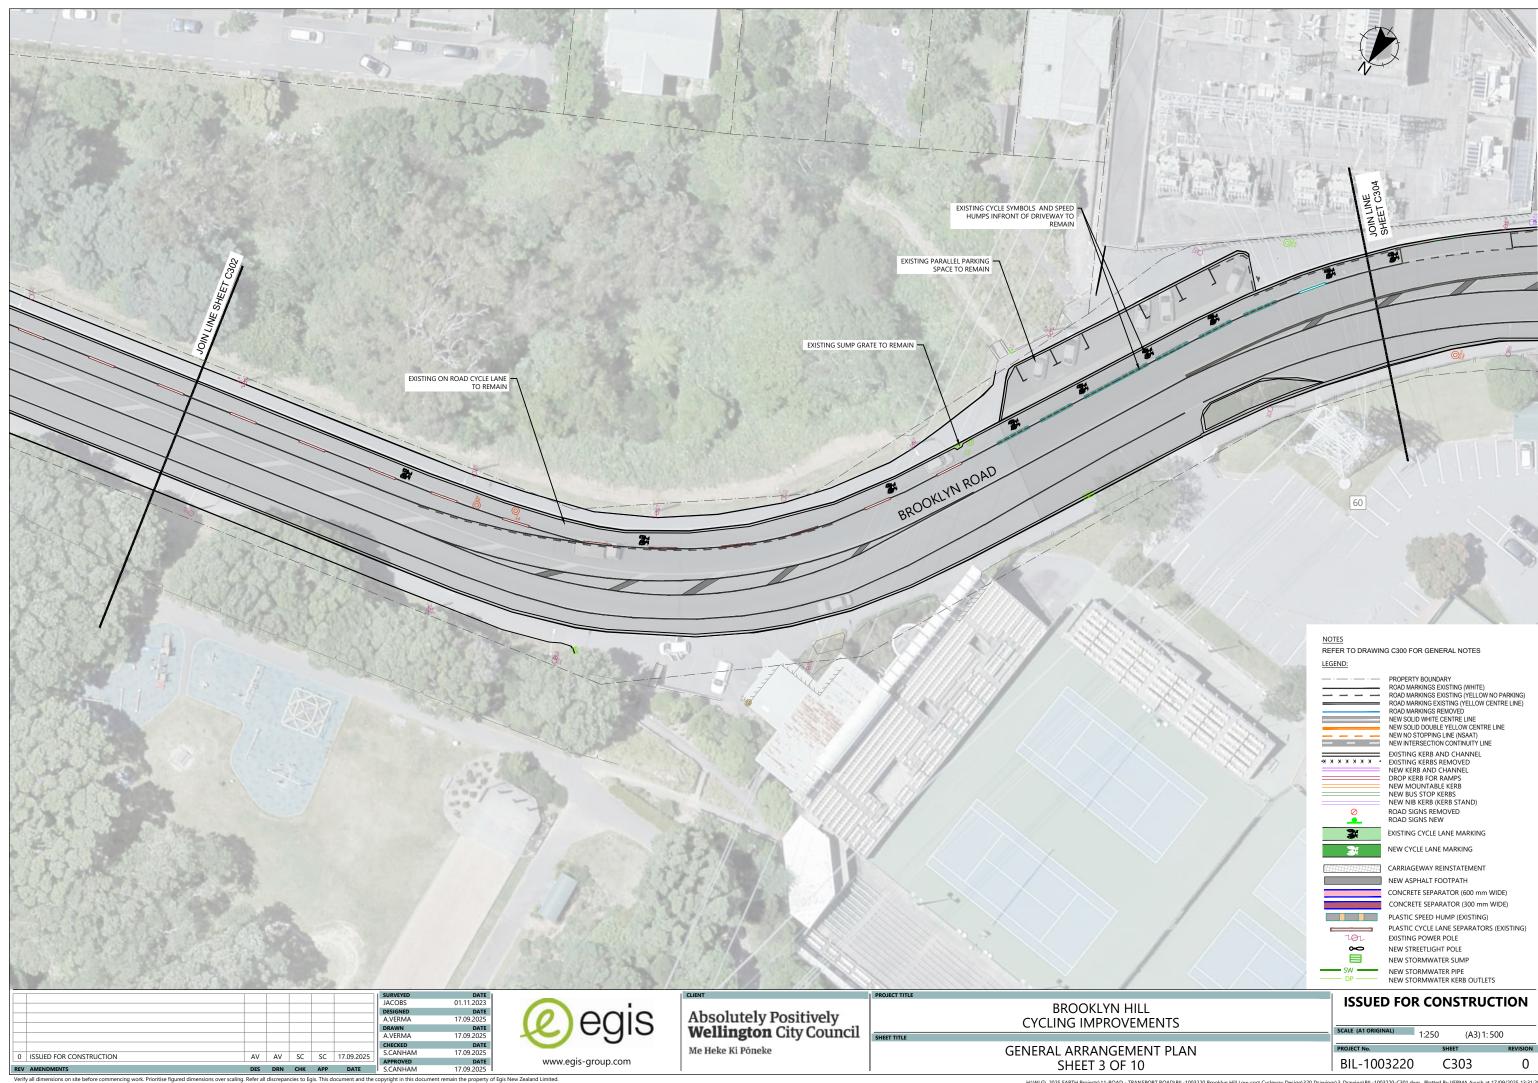


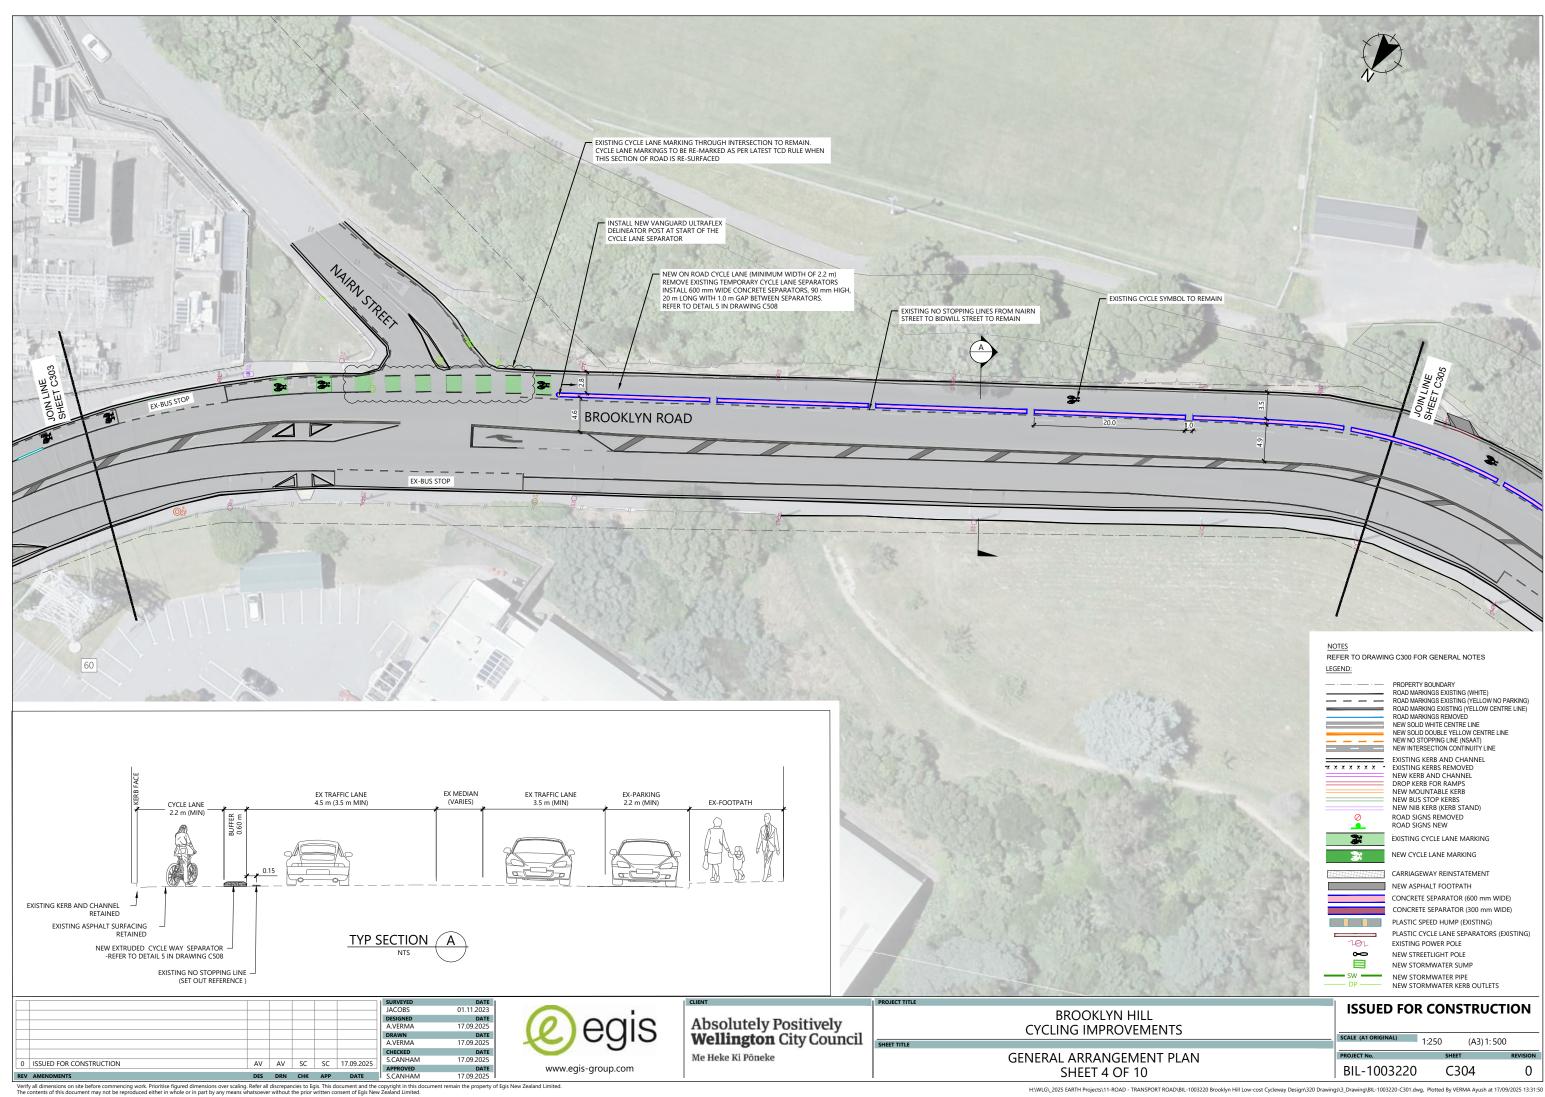


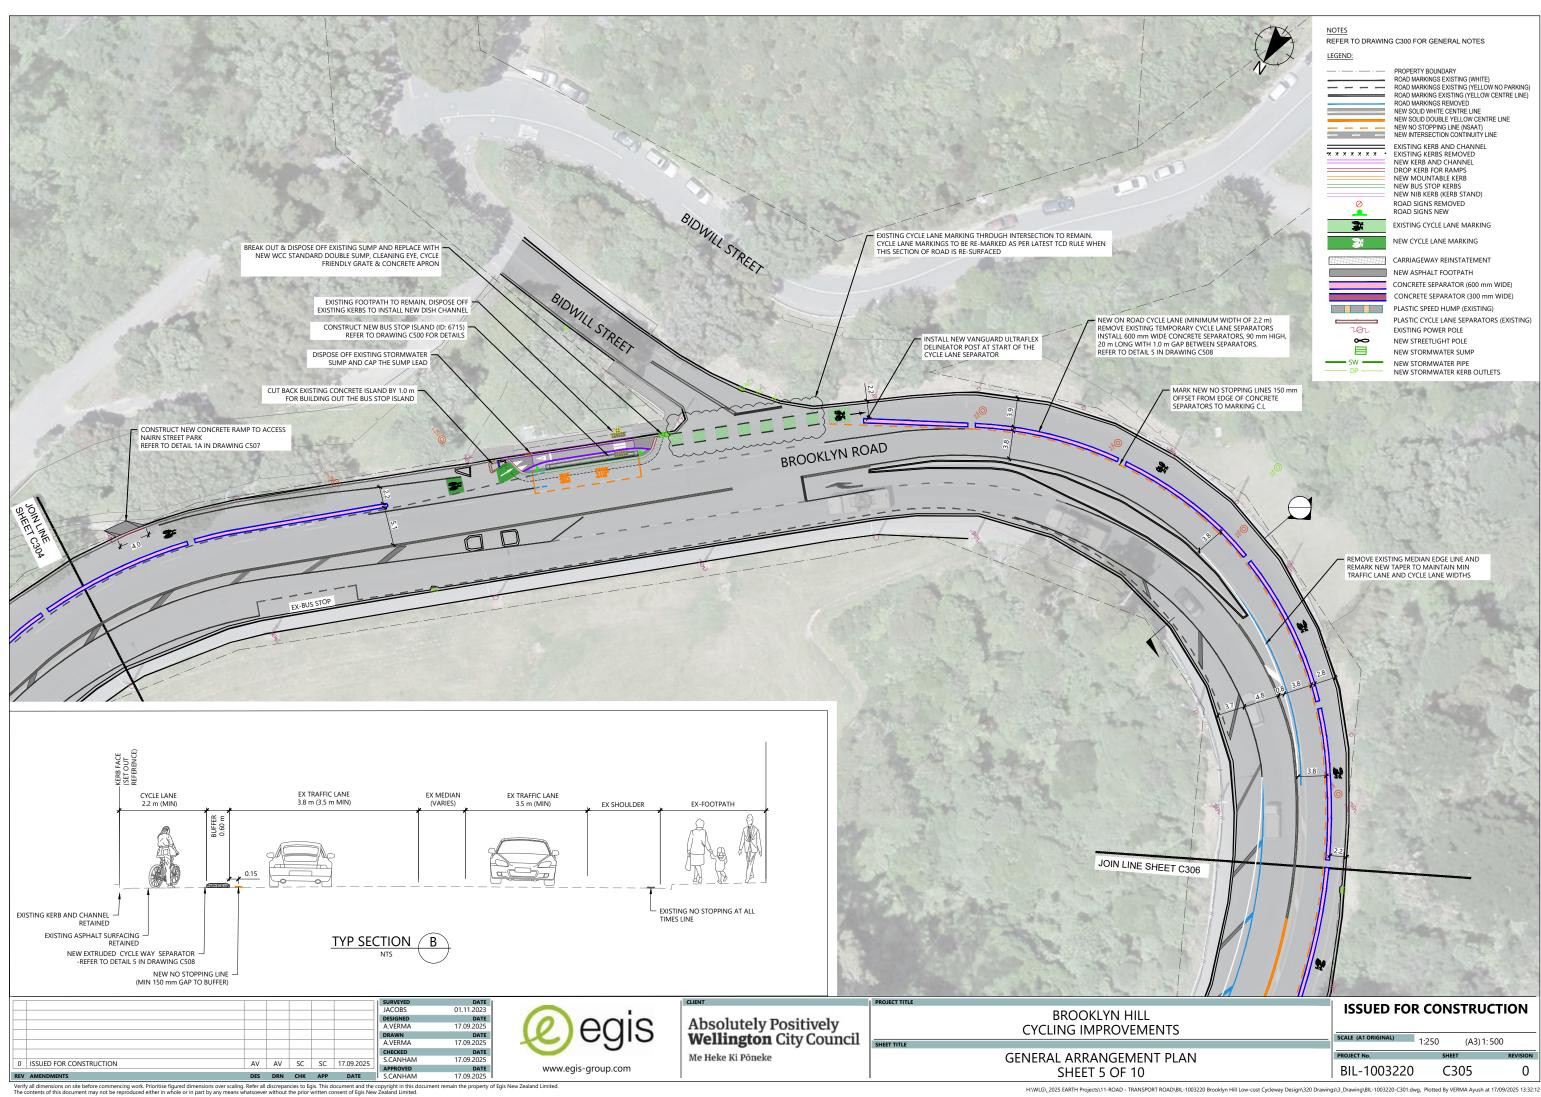


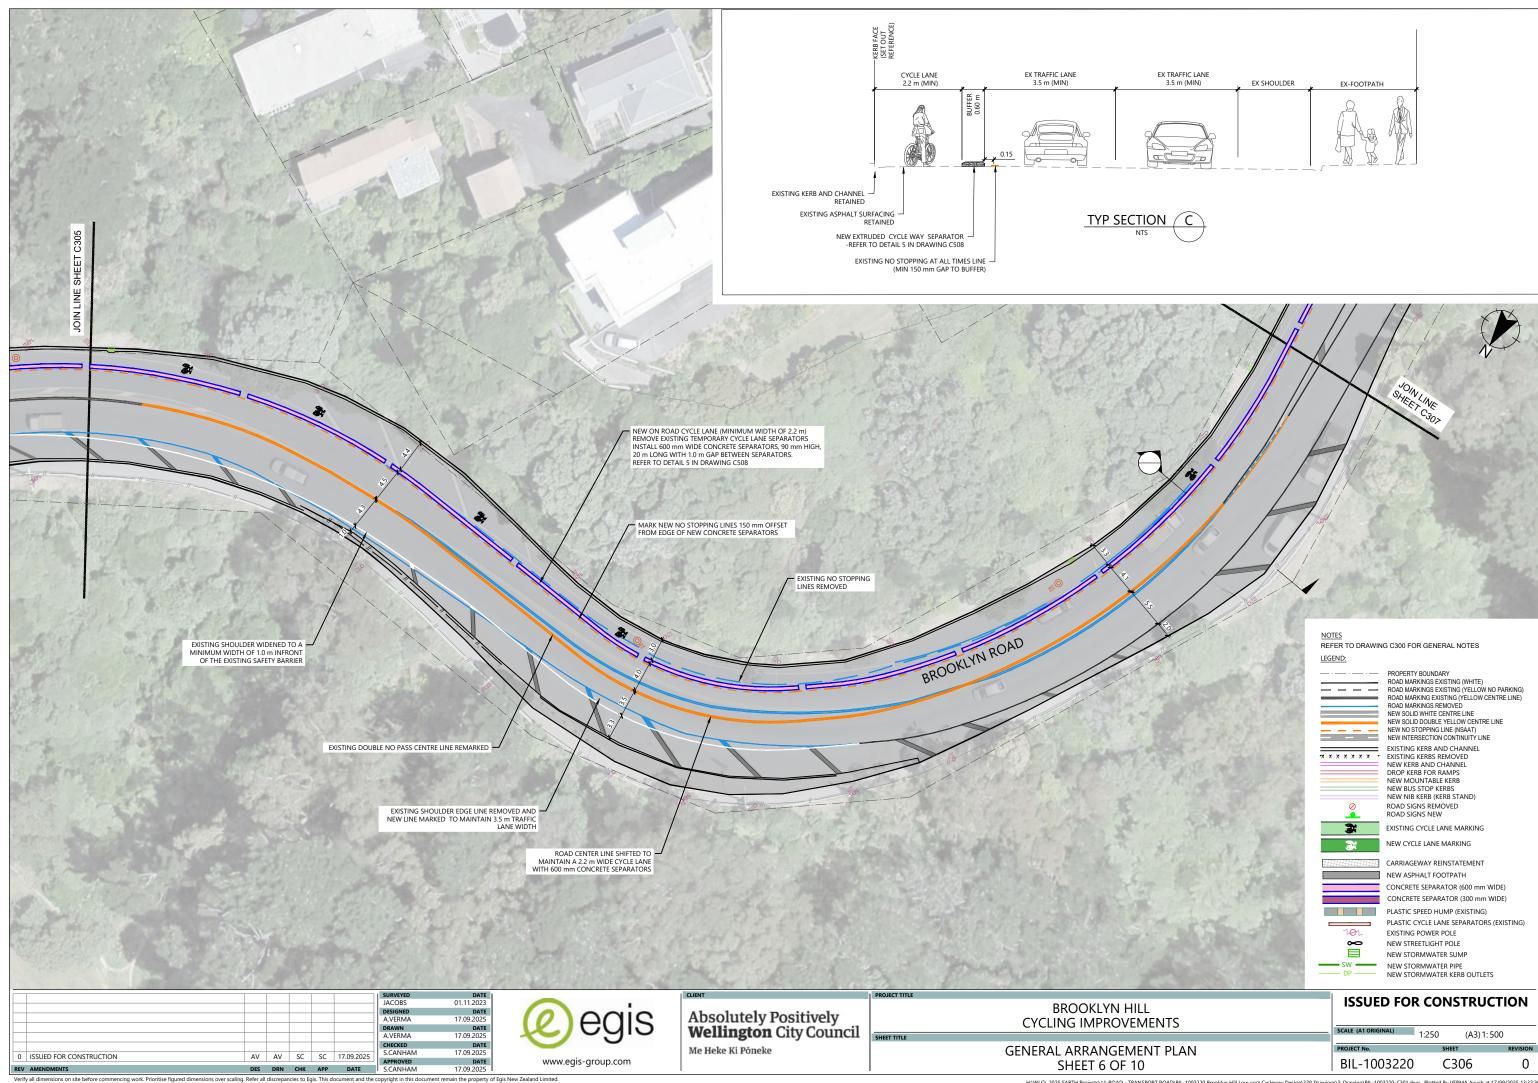


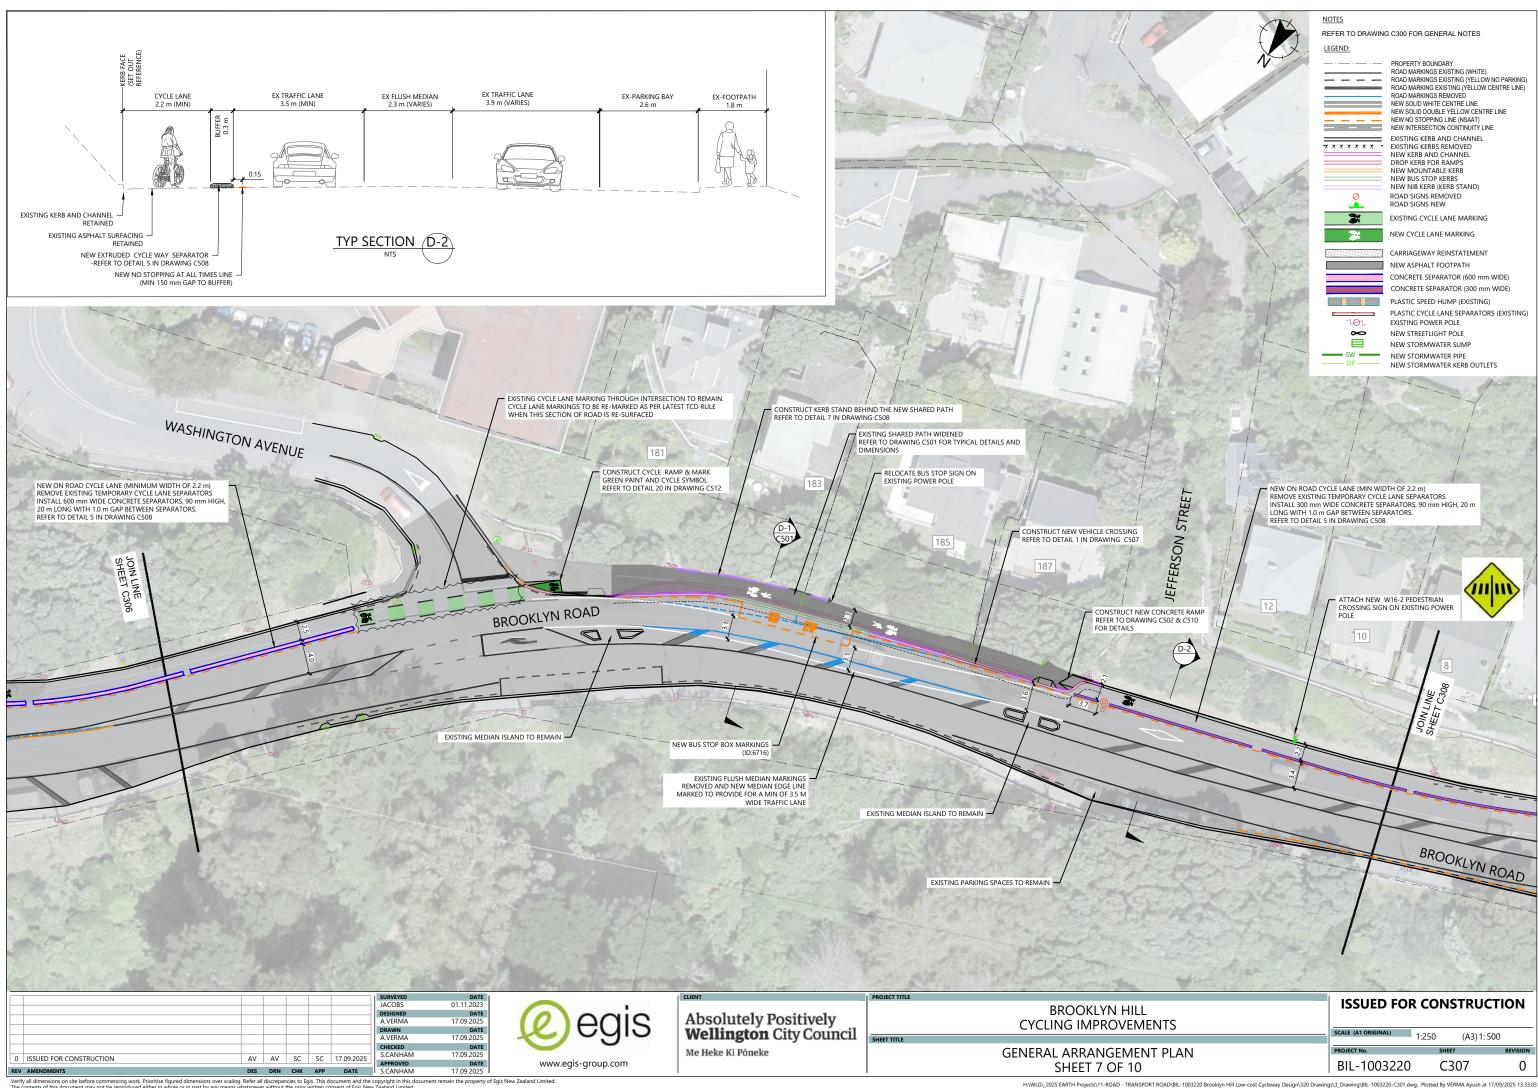


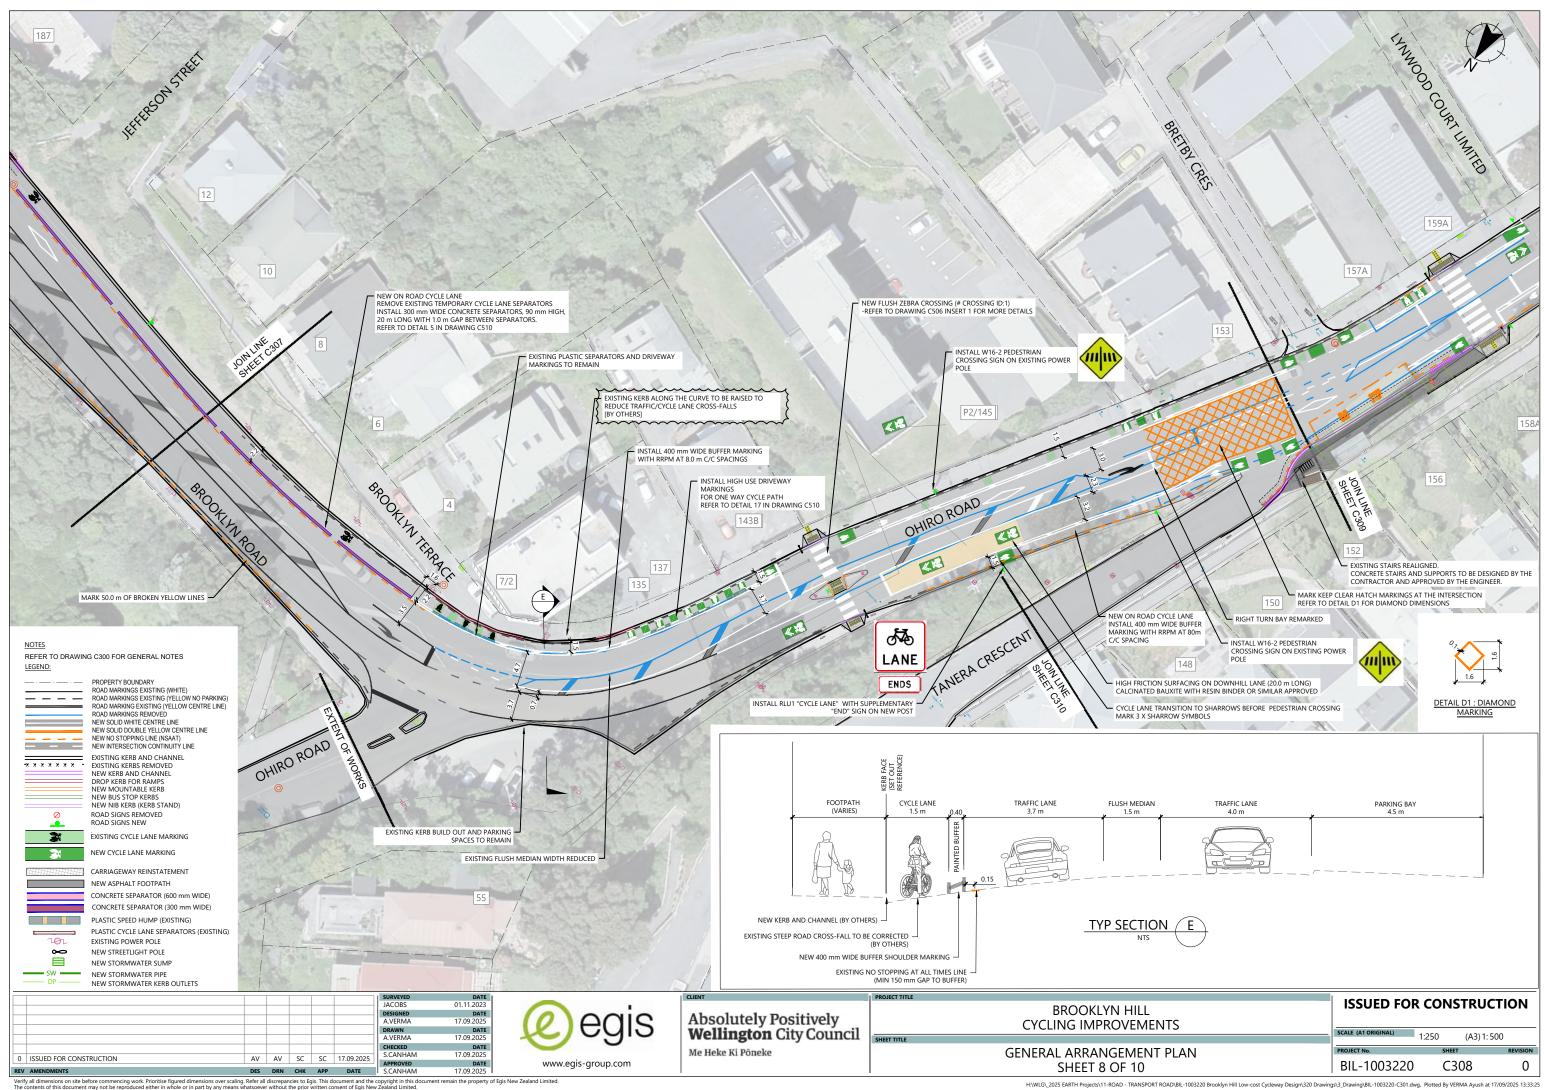


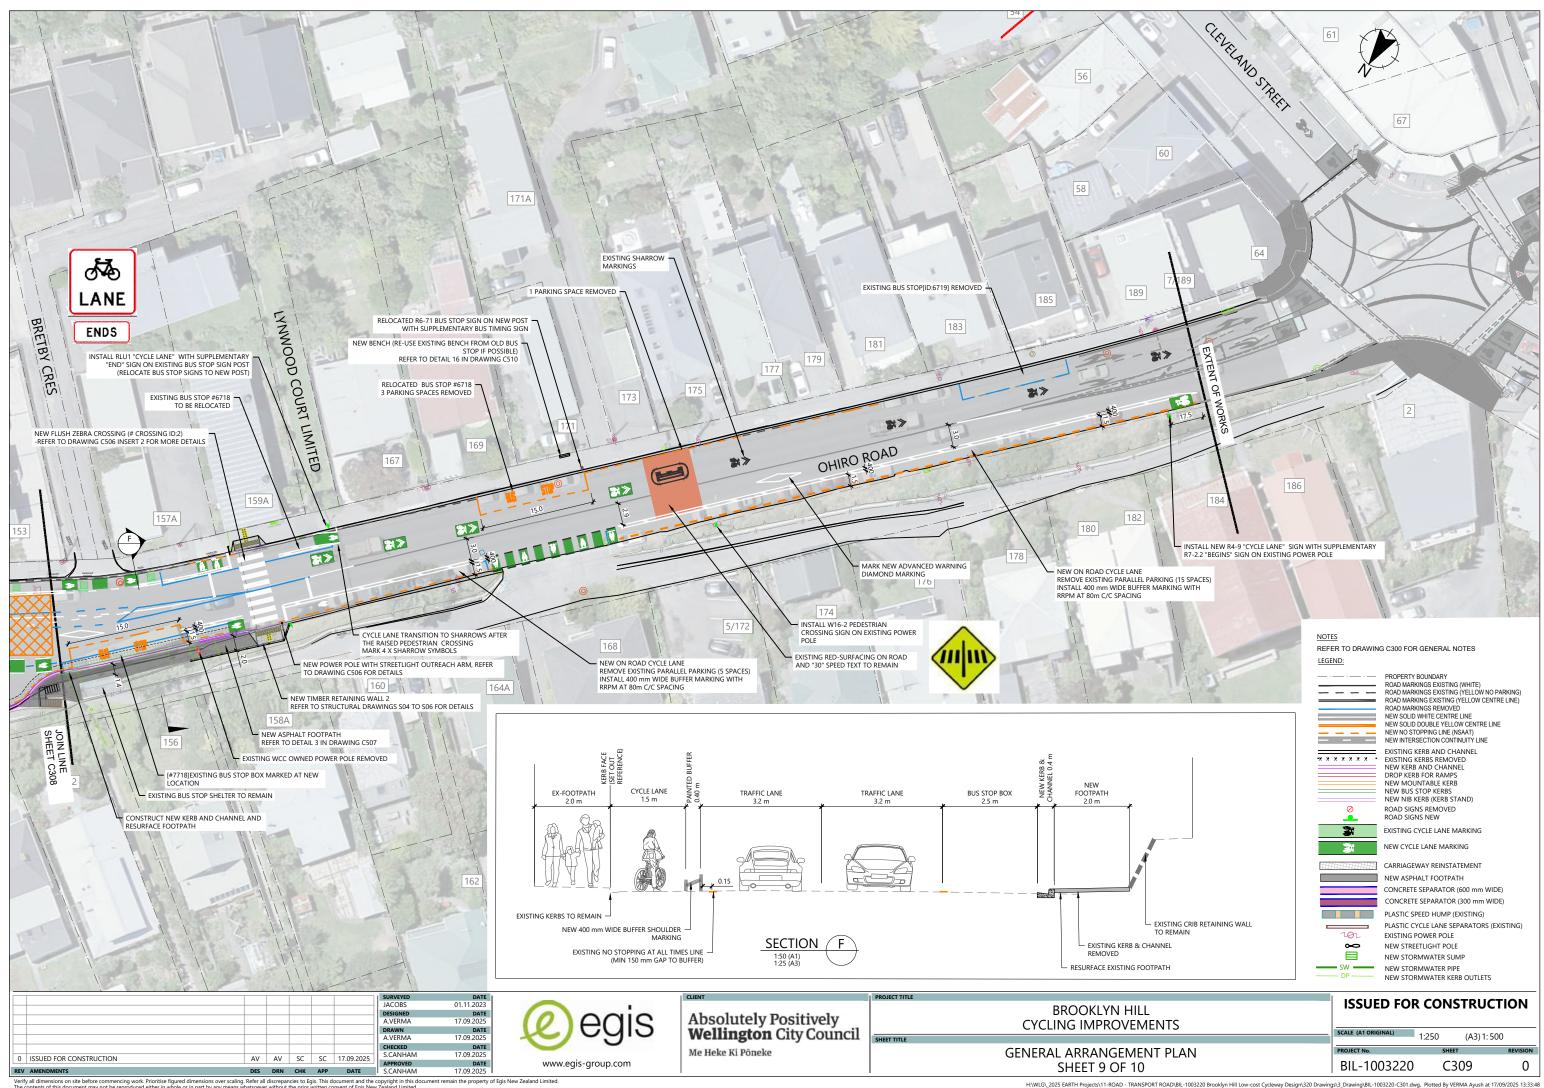


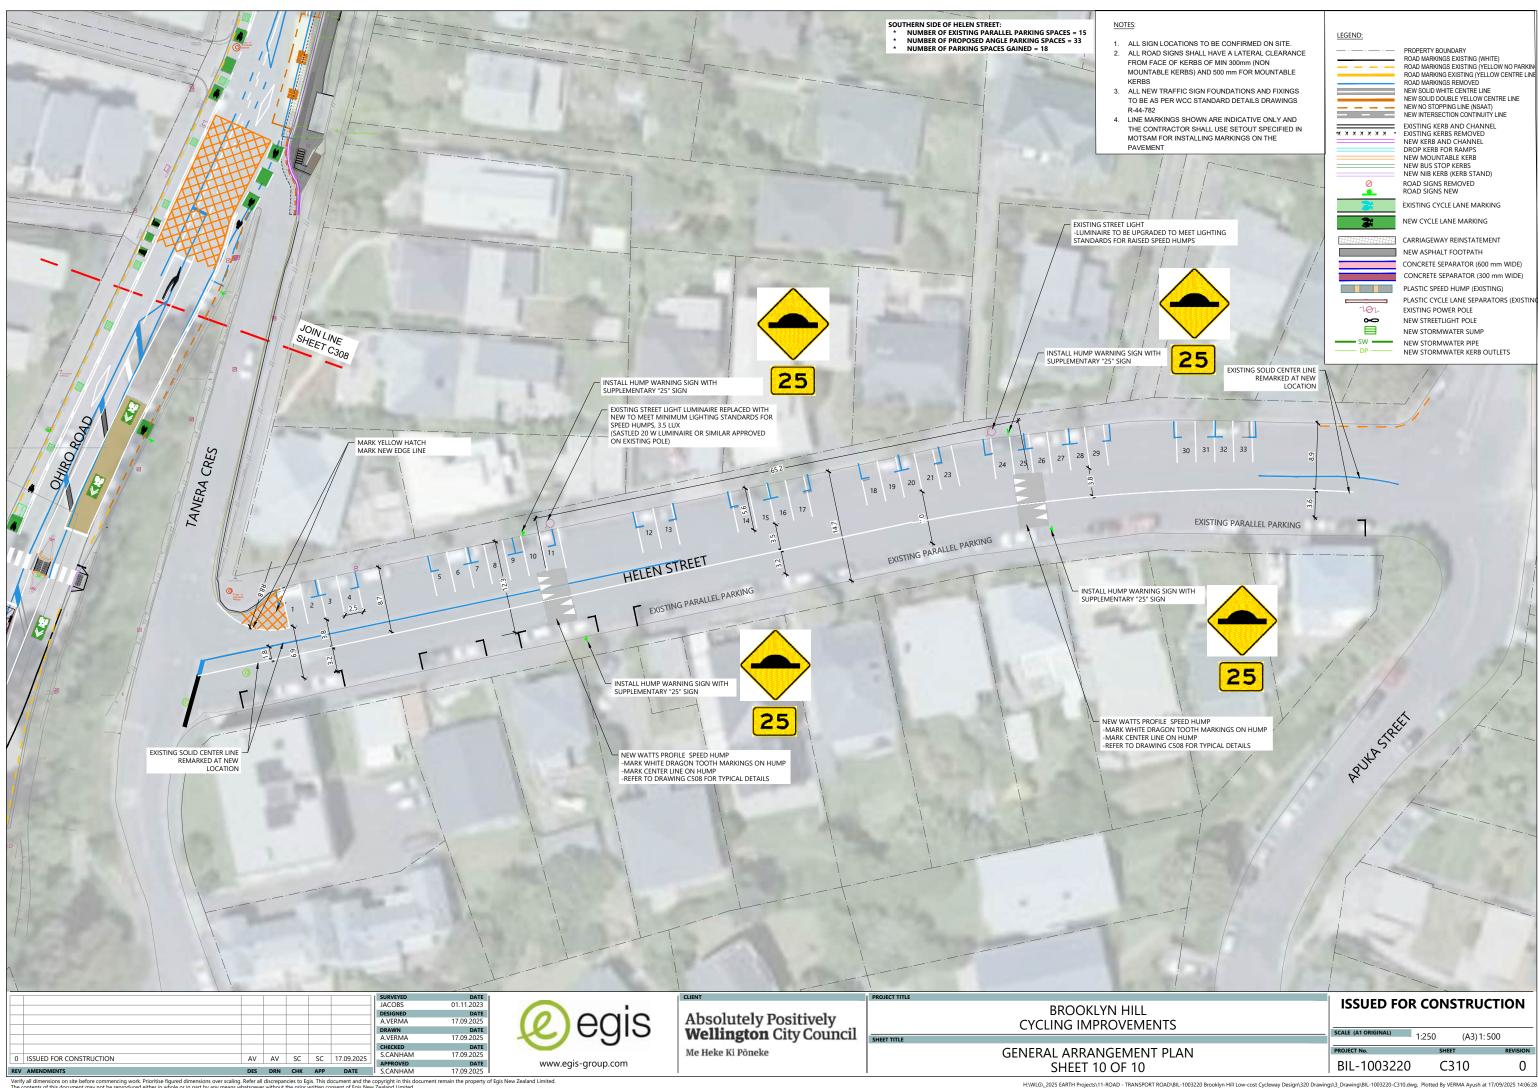


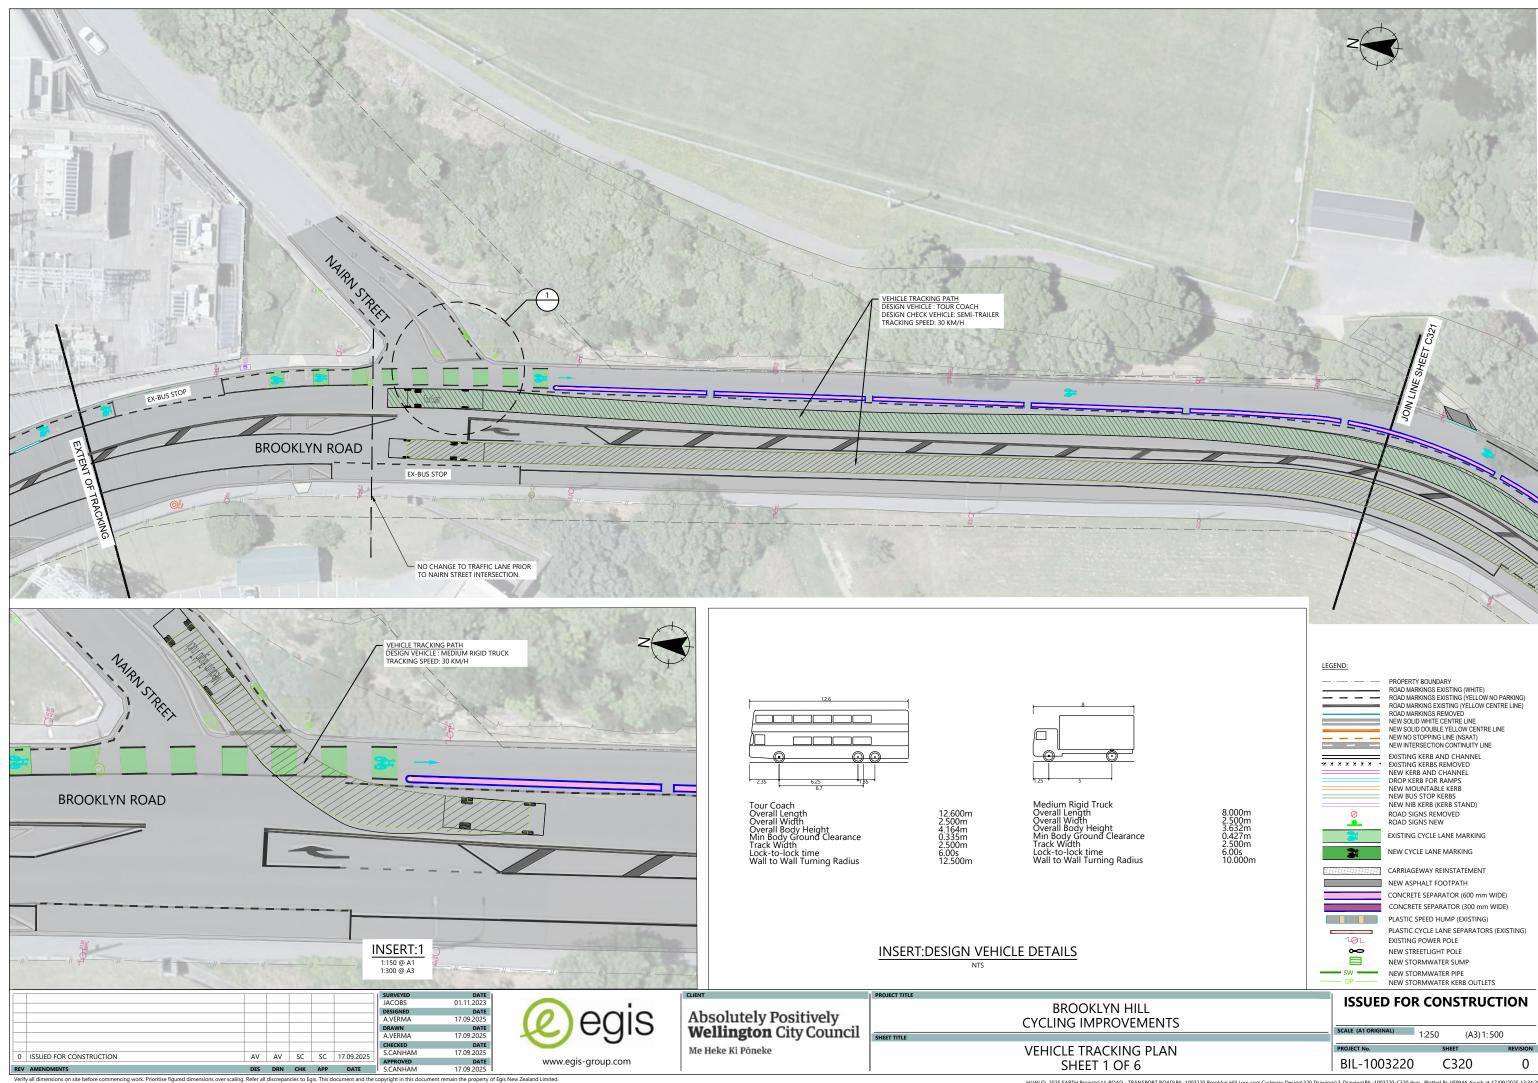


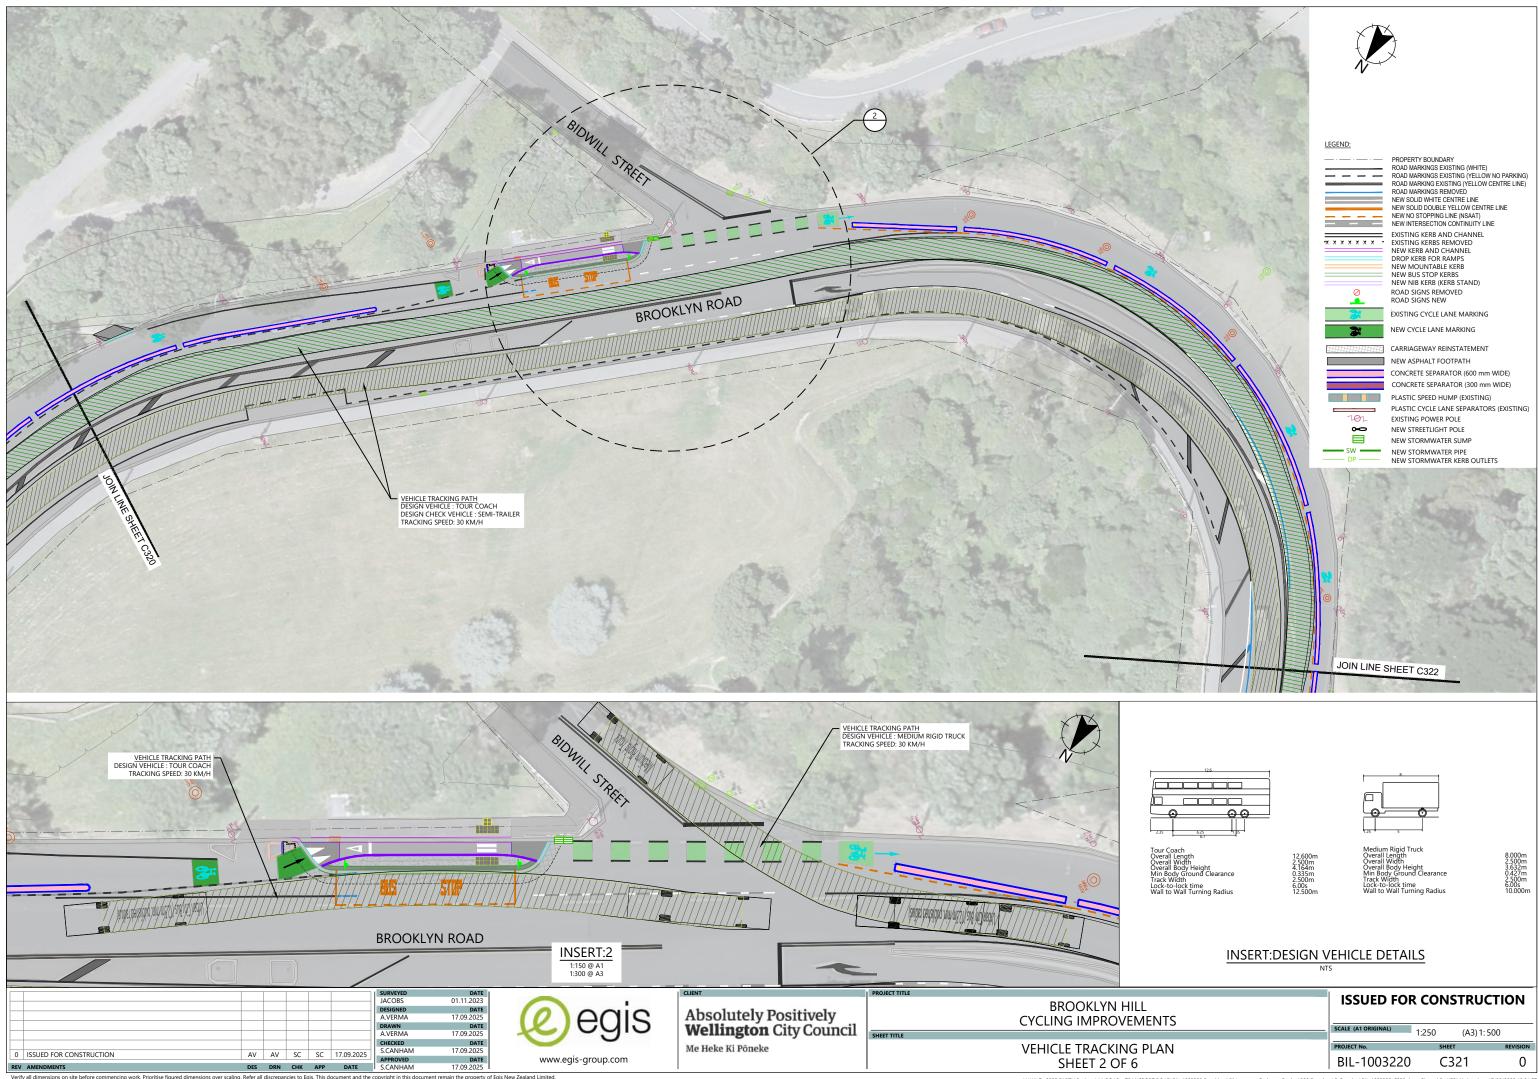


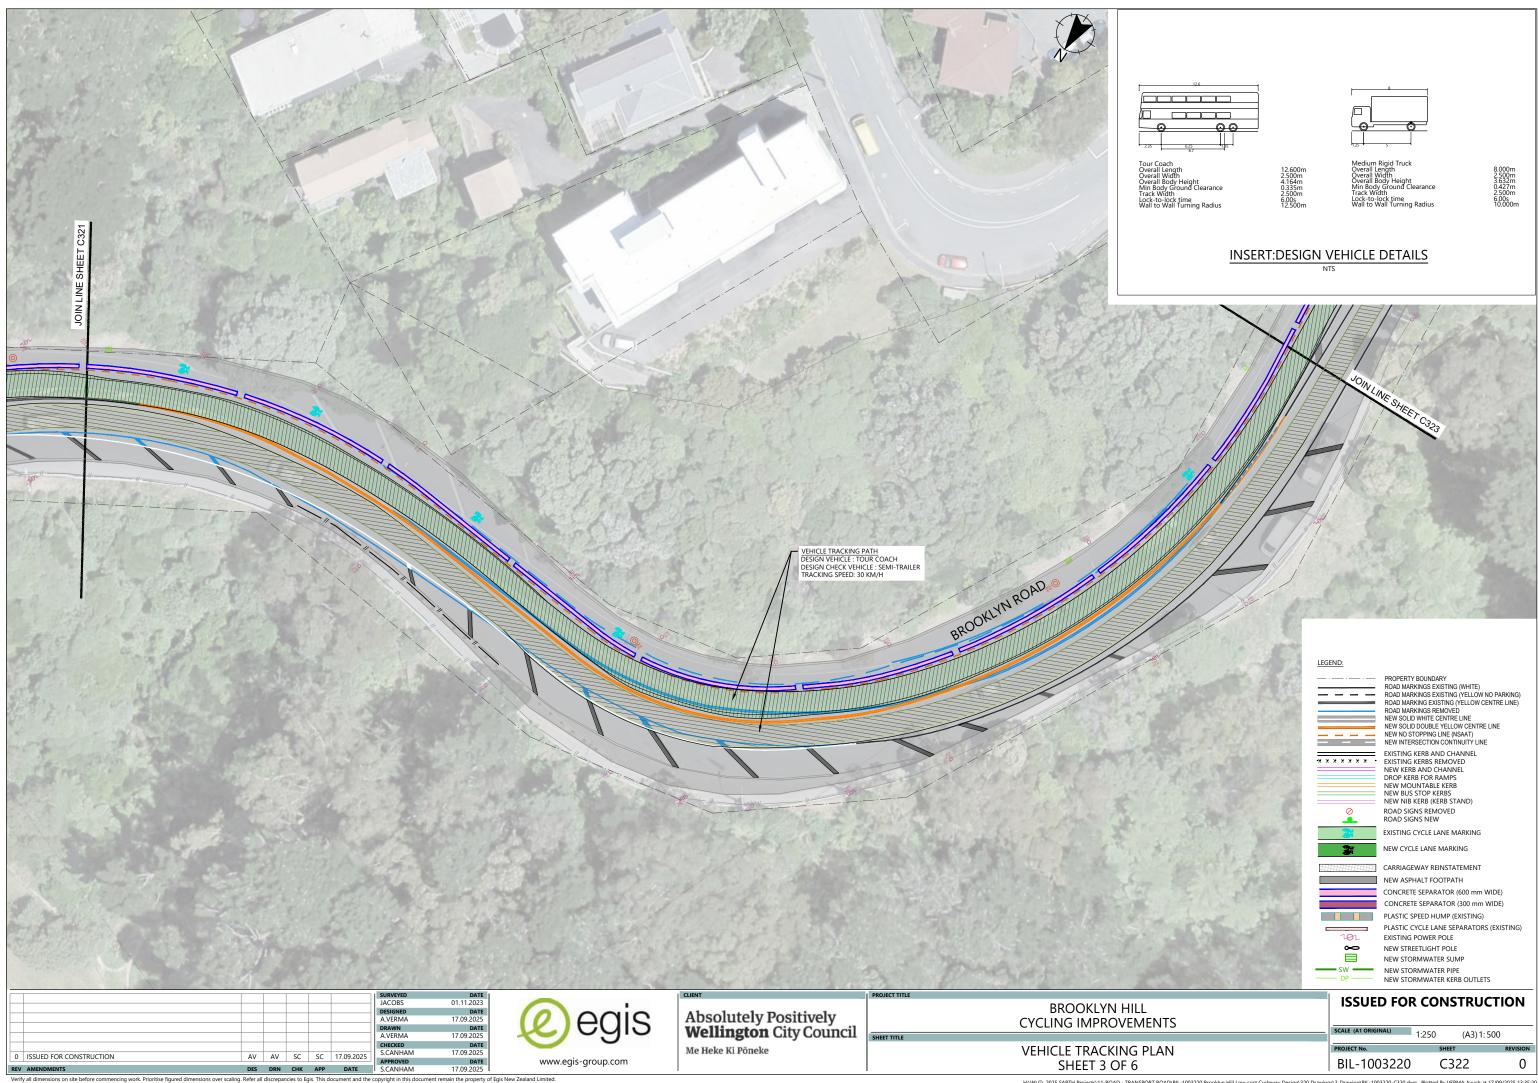


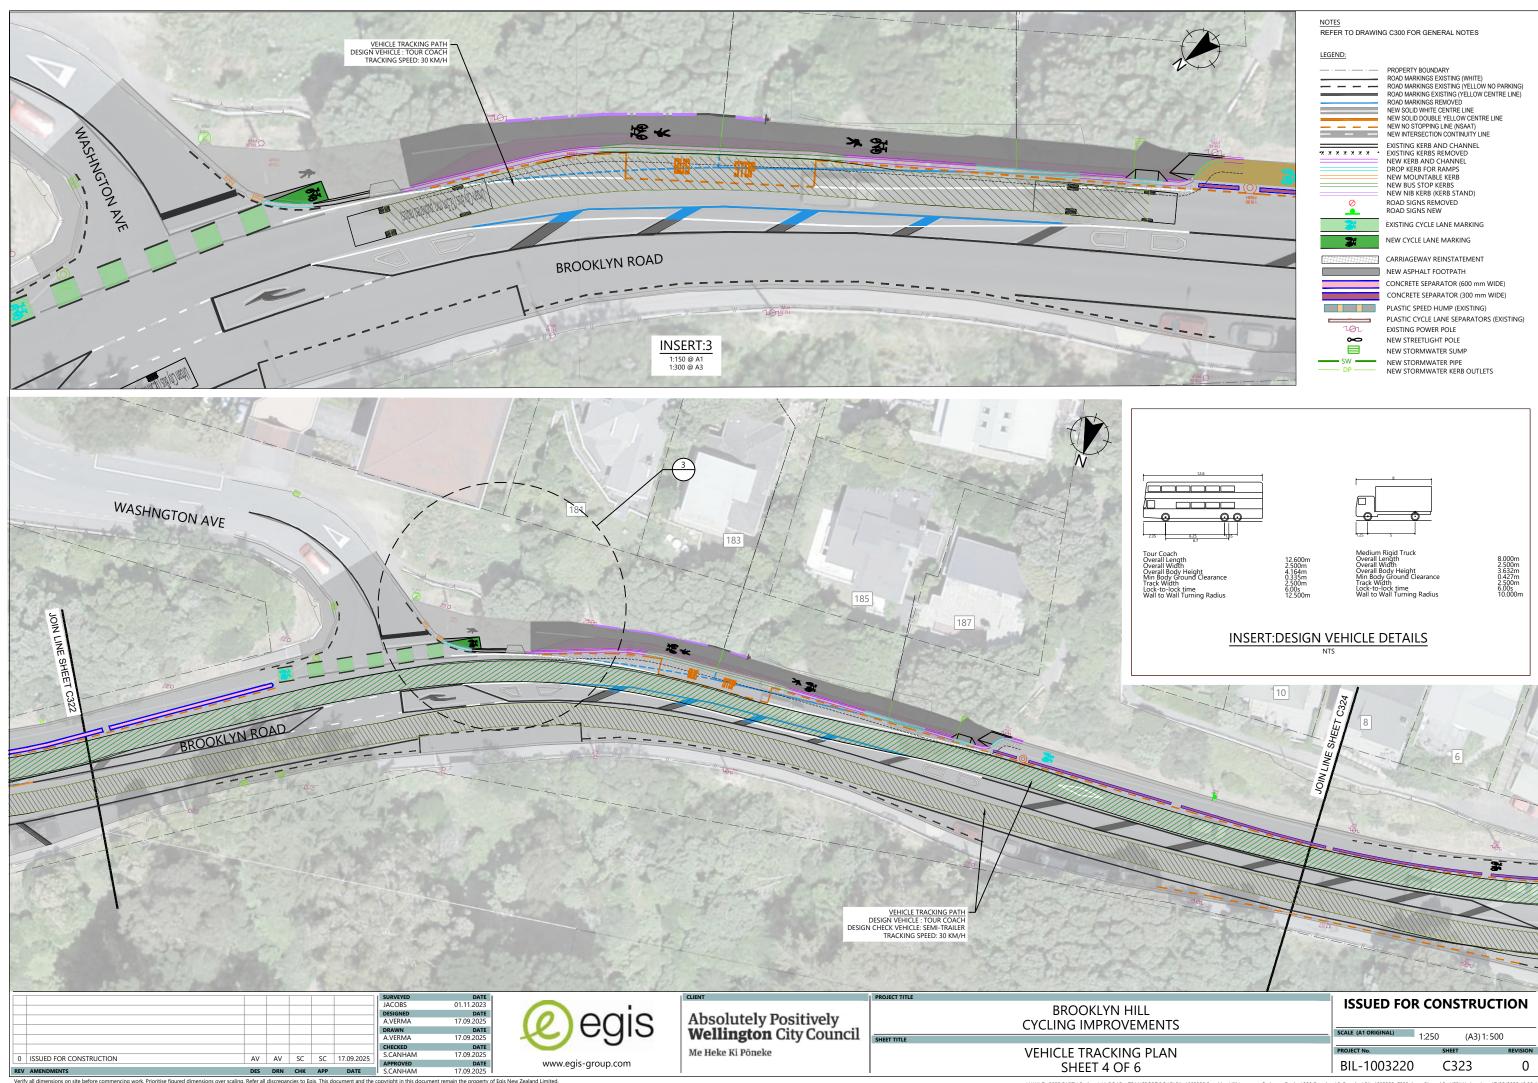


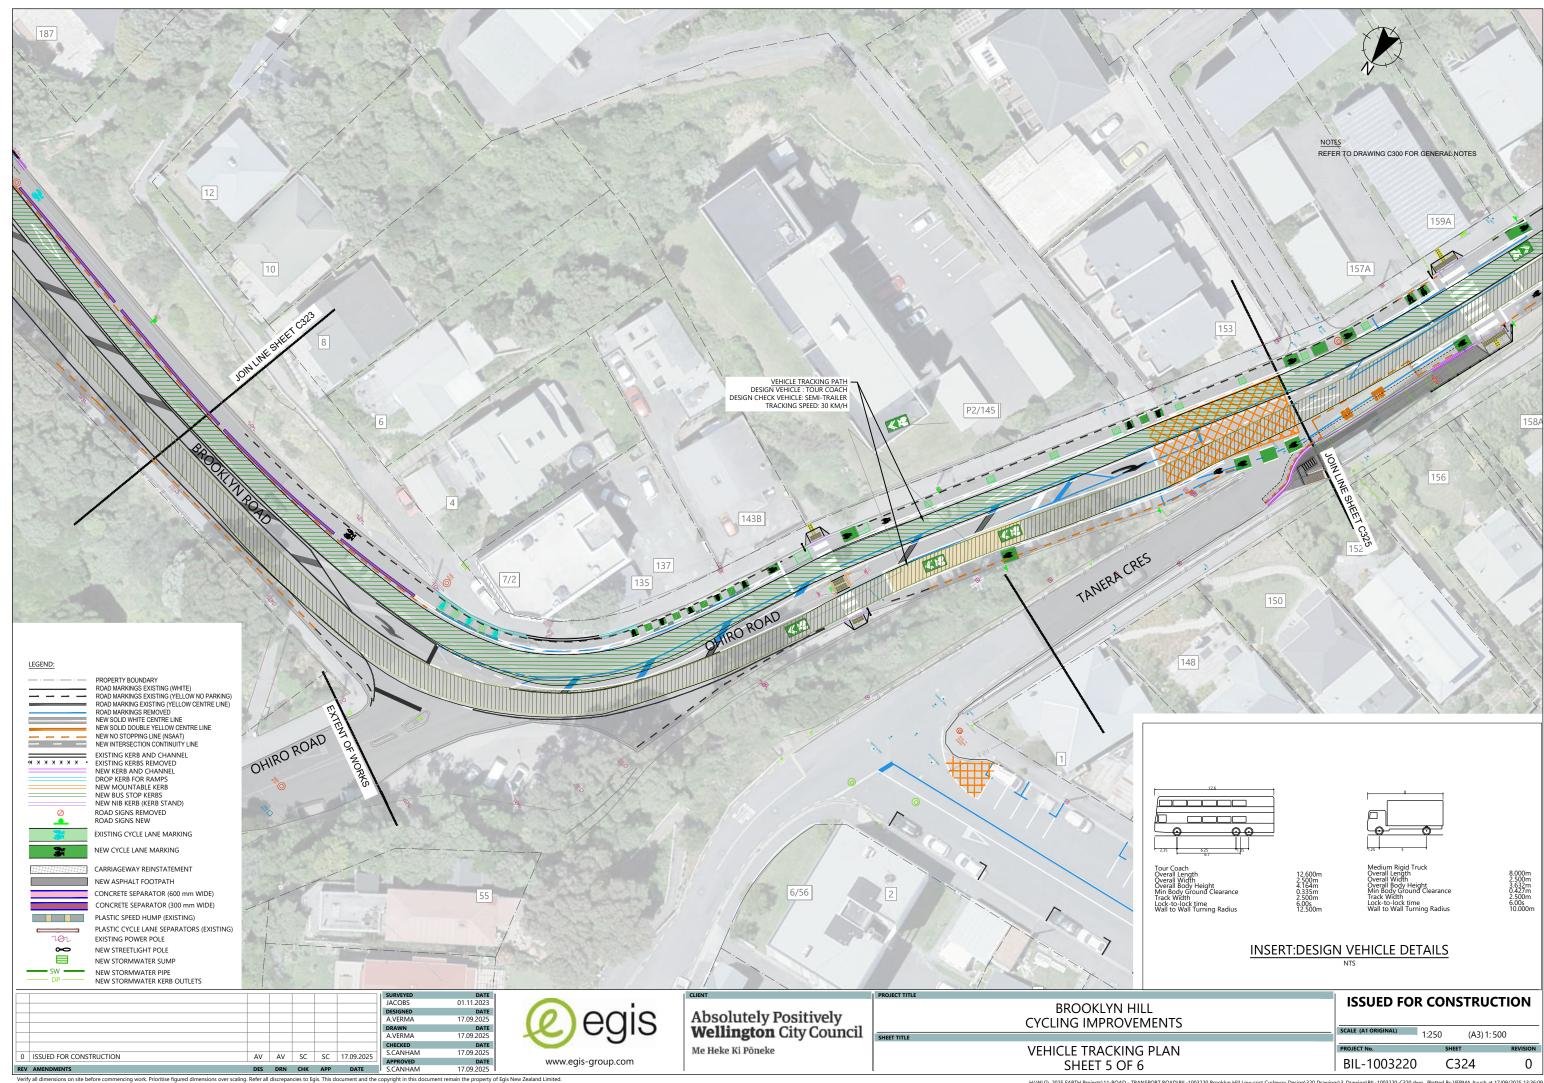


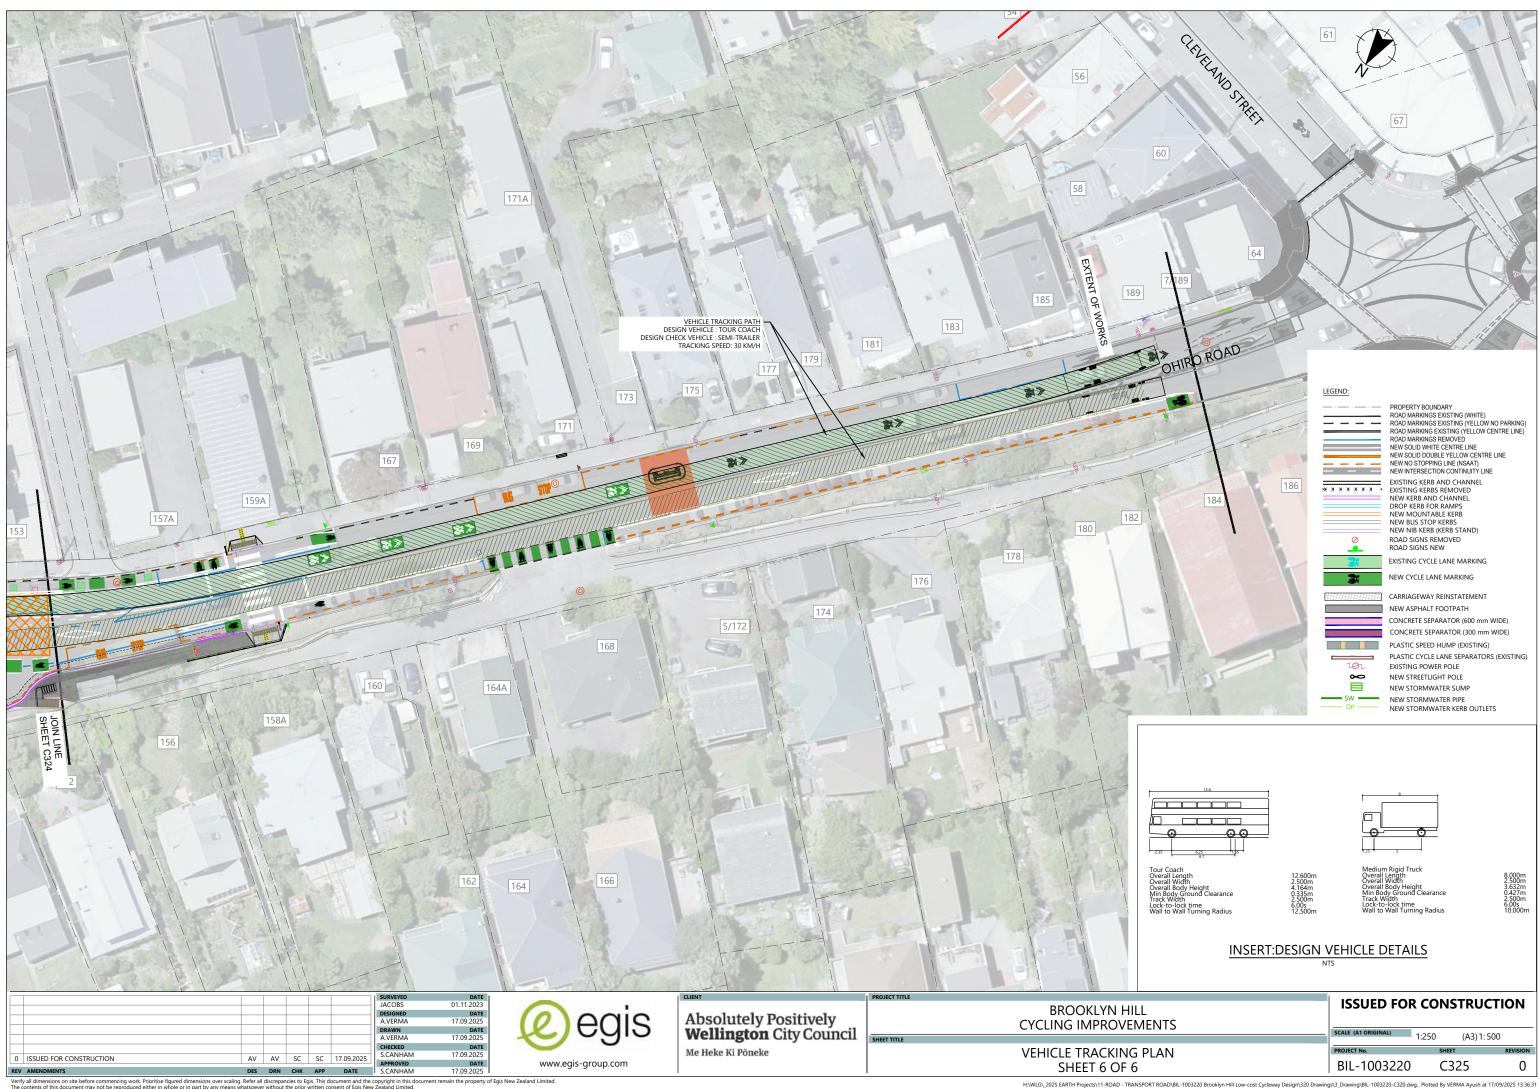


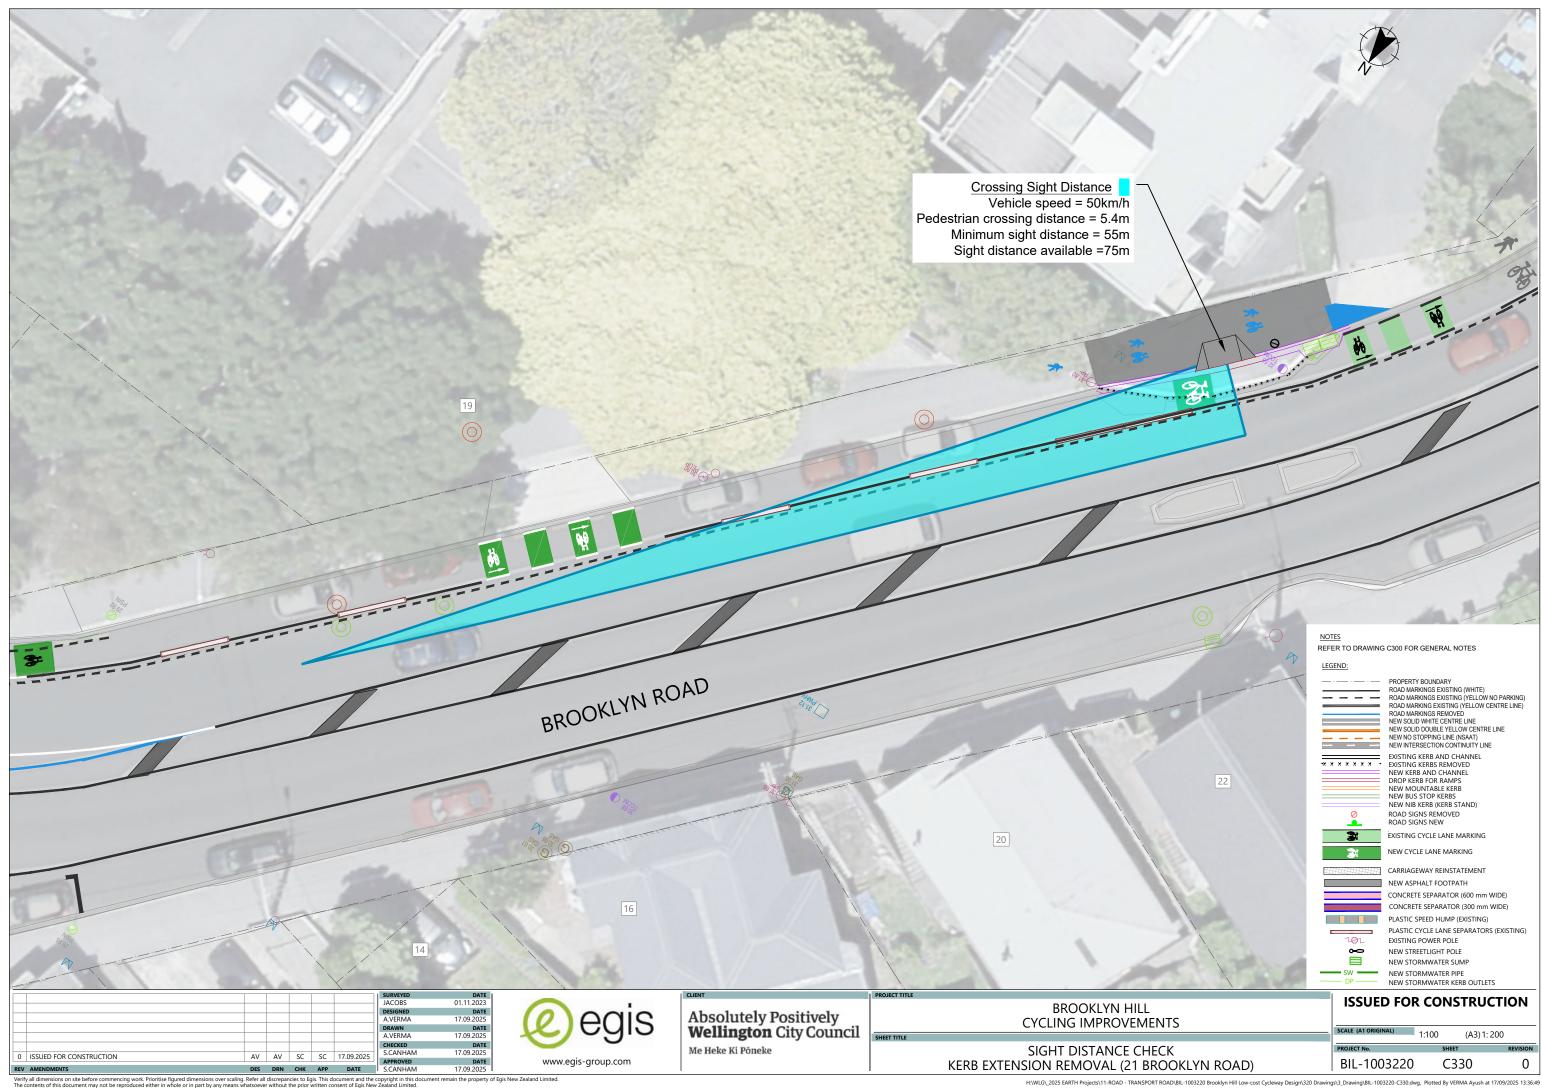

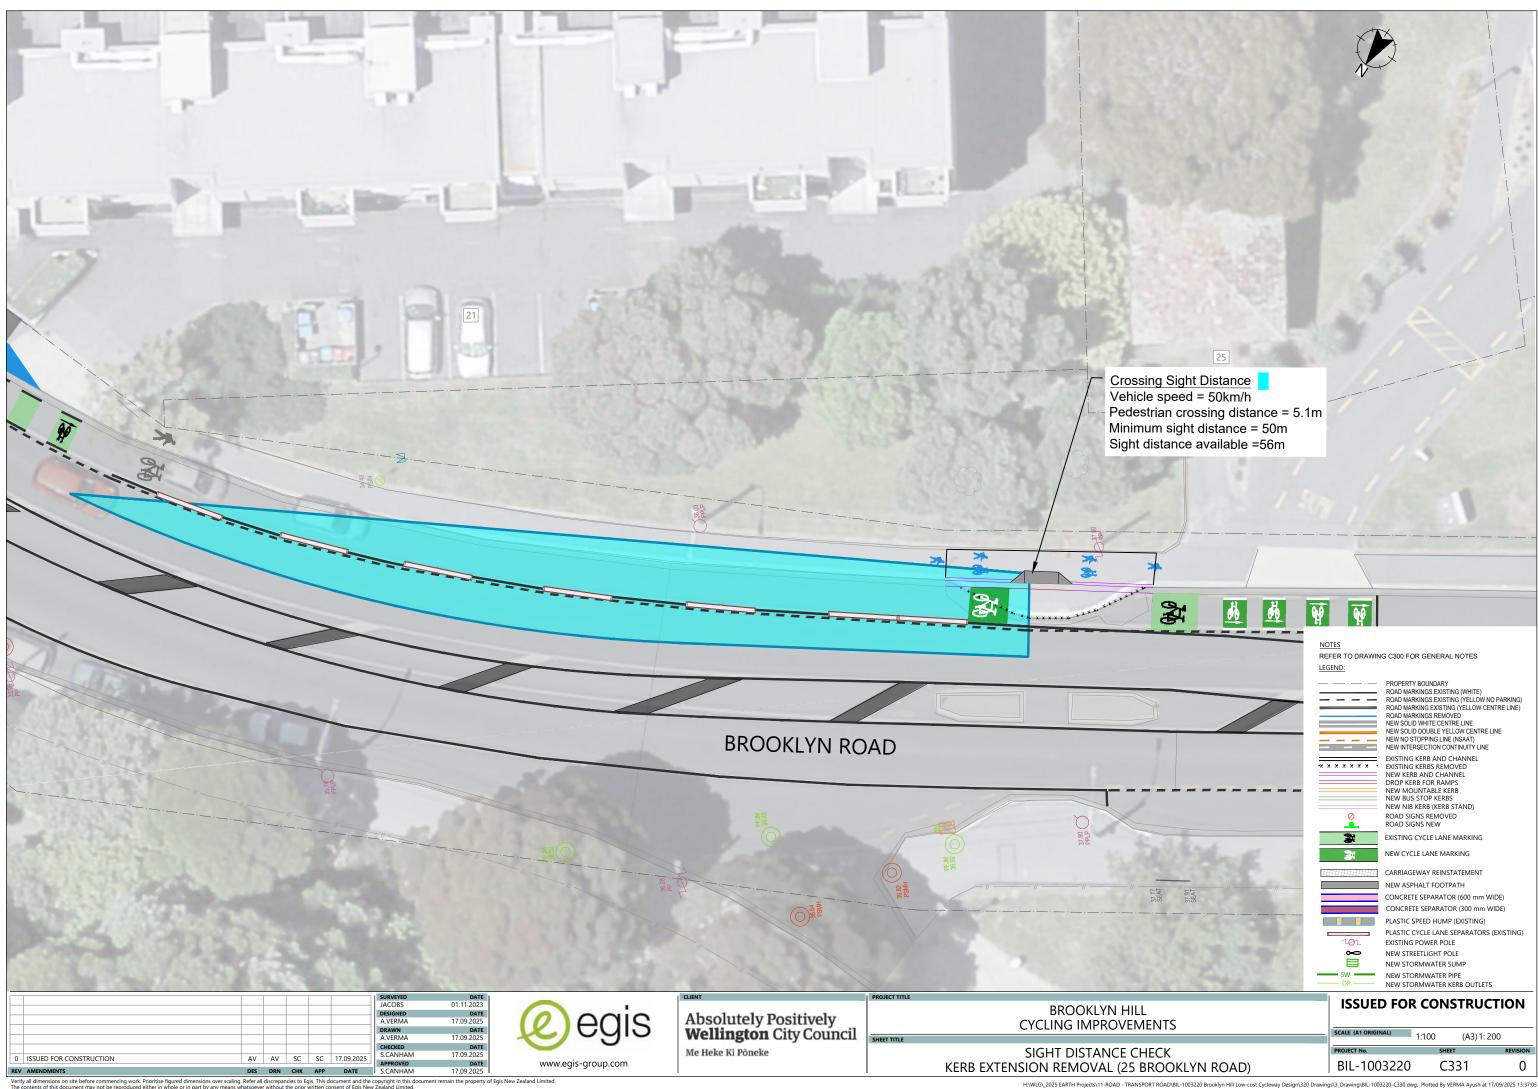

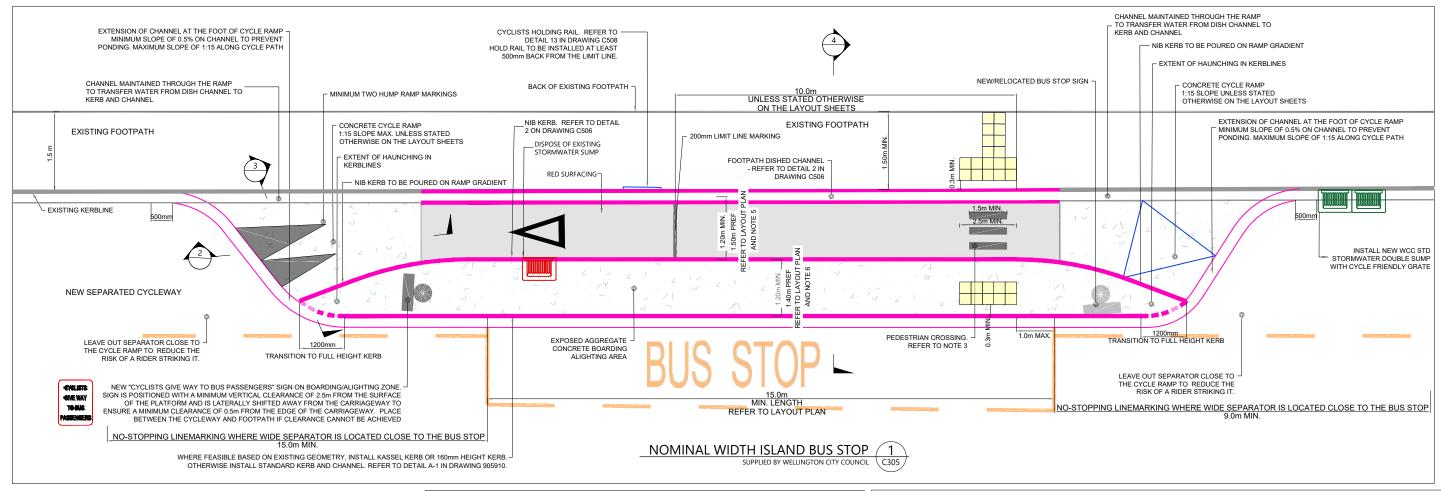

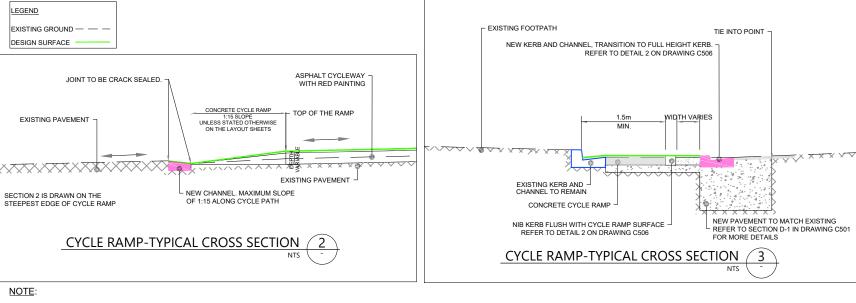

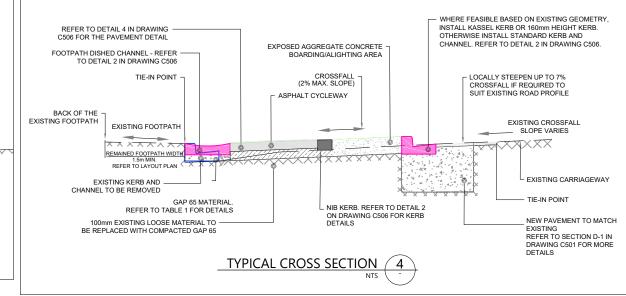

- ALL STORMWATER CATCHPITS MUST HAVE A CYCLE FRIENDLY LID. PEDESTRIAN CROSSING MARKING INCLUDES 200 WIDE (MIN.) BARS AND 200mm GAP.
- WHERE THE CROSSFALL OF NEW BUS ISLAND IS TOWARD THE EXISTING CARRIAGEWAY OR EXISTING FOOTPATH SLOPED TO THE BACK OF FOOTPATH THERE IS NO REQUIREMENT TO INSTALL DISHED CHANNEL BETWEEN THE EXISTING FOOTPATH AND NEW CYCLE LANE.
- CYCLE SPACE:
  WIDTH GREATER THAN 1.5m IS NOT DESIRABLE AS NARROW WIDTH HELP DIRECT CYCLISTS AND HIGHLIGHT CONFLICT AREA.
  SHY SPACE IS REQUIRED FROM ANY OBSTACLE
- RAMP WIDTH ARE MINIMUM 1.5m TO PROVIDE SPACE FOR WIDE BIKES
- CYCLE SPACE FORMED FROM ASPHALT AS AN INFILL BETWEEN DISH CHANNEL AND BOARDING/ALIGHTING PLATFORM
- BOARDING/ALIGHTING PLATFORM: WHERE POSSIBLE WIDTH OF PLATFORM SHOULD BE EQUAL OR WIDER THAN CYCLESPACE CONSTRUCTED WITH EXPOSED AGGREGATE SURFACE

- FOOTPATH AREA:
   SHY SPACE IS REQUIRED FROM ANY OBSTACLE SUCH AS A HIGH FENCE OR POWER POLE


TABLE 1: PAVEMENT CONTINGENCY PLANS							
	SUBG	RADE IMPROVEMENT REQUIREM	OVEMENT REQUIREMENTS				
IN-SITU CBR	BUS ISLAND AND FOOTPATH	KERB AND CHANNEL	PAVEMENT				
4%	NOT REQUIRED	150mm	NOT REQUIRED				
3%	NOT REQUIRED	150mm	NOT REQUIRED				
2%	150mm	300mm	150mm				
1%	300mm	600mm	300mm				
0.5%	450mm	900mm	450mm				


		1					SURVEYED	DATE
							_	
							DESIGNED	DATE
							DRAWN	DATE
							A.VERMA	17.09.2025
1							CHECKED	DATE
0	ISSUED FOR CONSTRUCTION	AV	AV	SC	SC	17.09.2025	S.CANHAM	17.09.2025
	1550ED FOR CONSTRUCTION	_ ~v	_ ~v	- JC		17.05.2025	APPROVED	DATE
REV	AMENDMENTS	DES	DRN	СНК	APP	DATE	S.CANHAM	17.09.2025




CLIENT
Absolutely Positively <b>Wellington</b> City Counci
Me Heke Ki Pôneke

	PROJECT TITLE			
у	BROOKLYN HILL CYCLING IMPROVEMENTS	ISSUED FOR	R CONSTRUCT	ION
ncil	SHEET TITLE	SCALE (A1 ORIGINAL)	SCALE AS NOTED	ALWAYS CHECK SCALE
	TYPICAL DETAILS	PROJECT No.	SHEET	REVISION
	BUS STOP ISLAND (ID:6715)	BIL-1003220	500	0

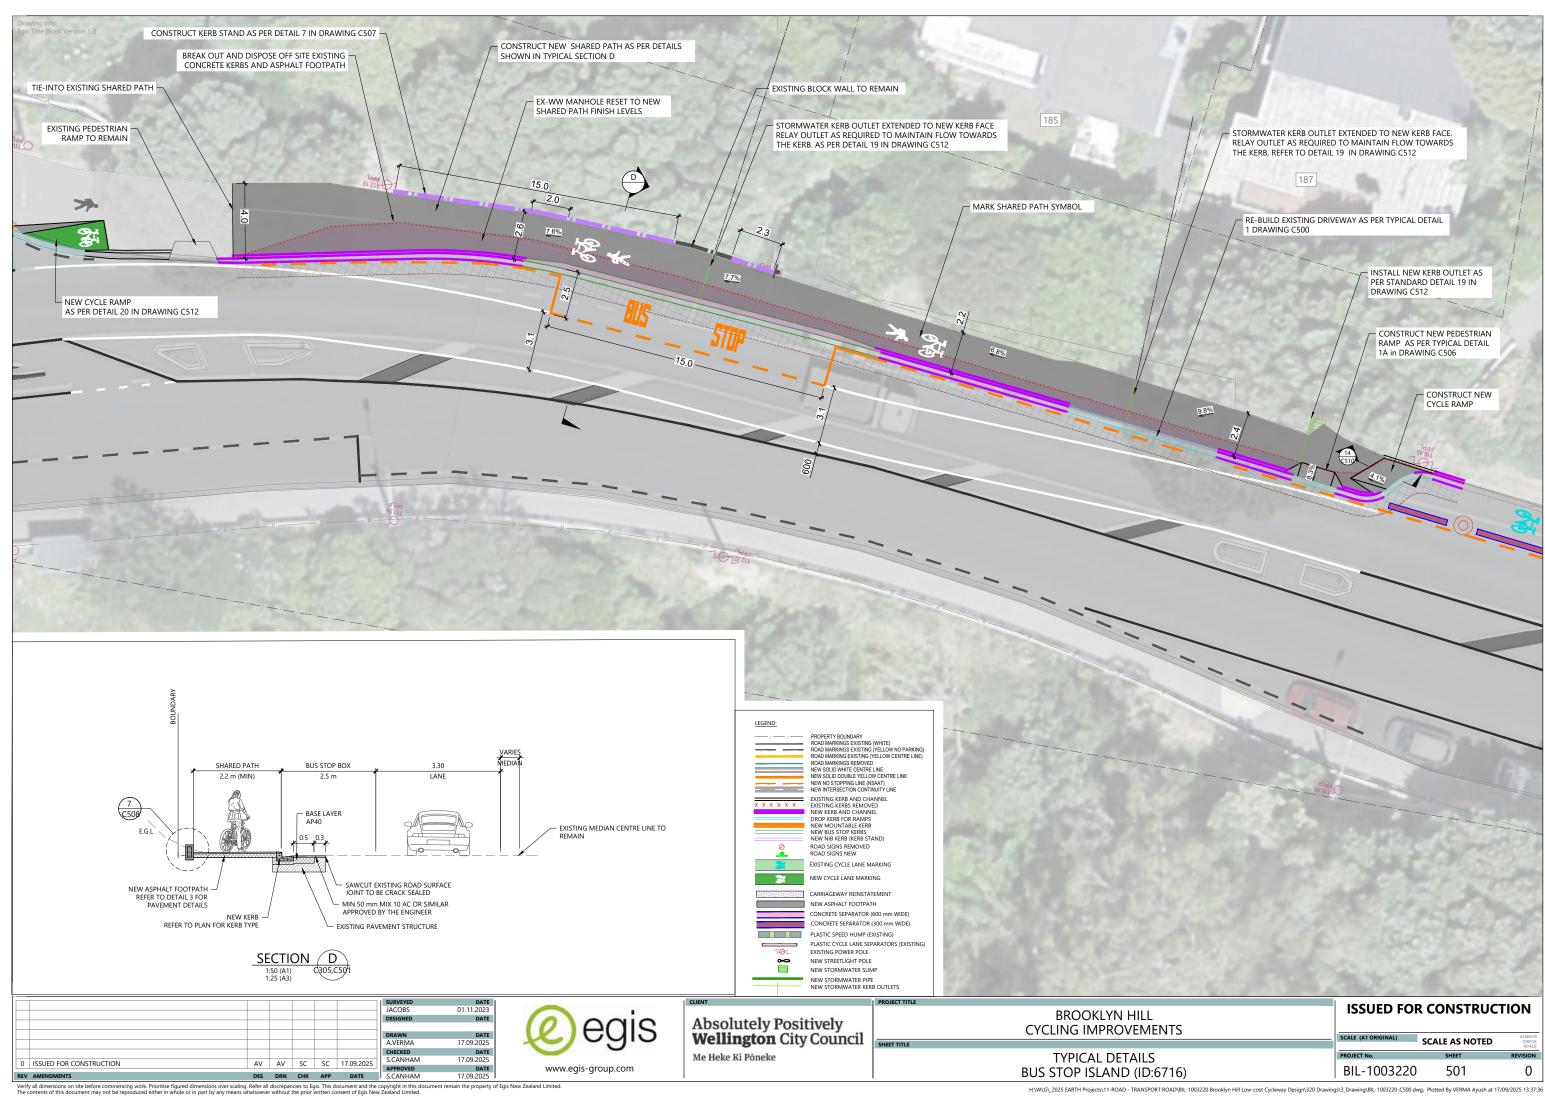

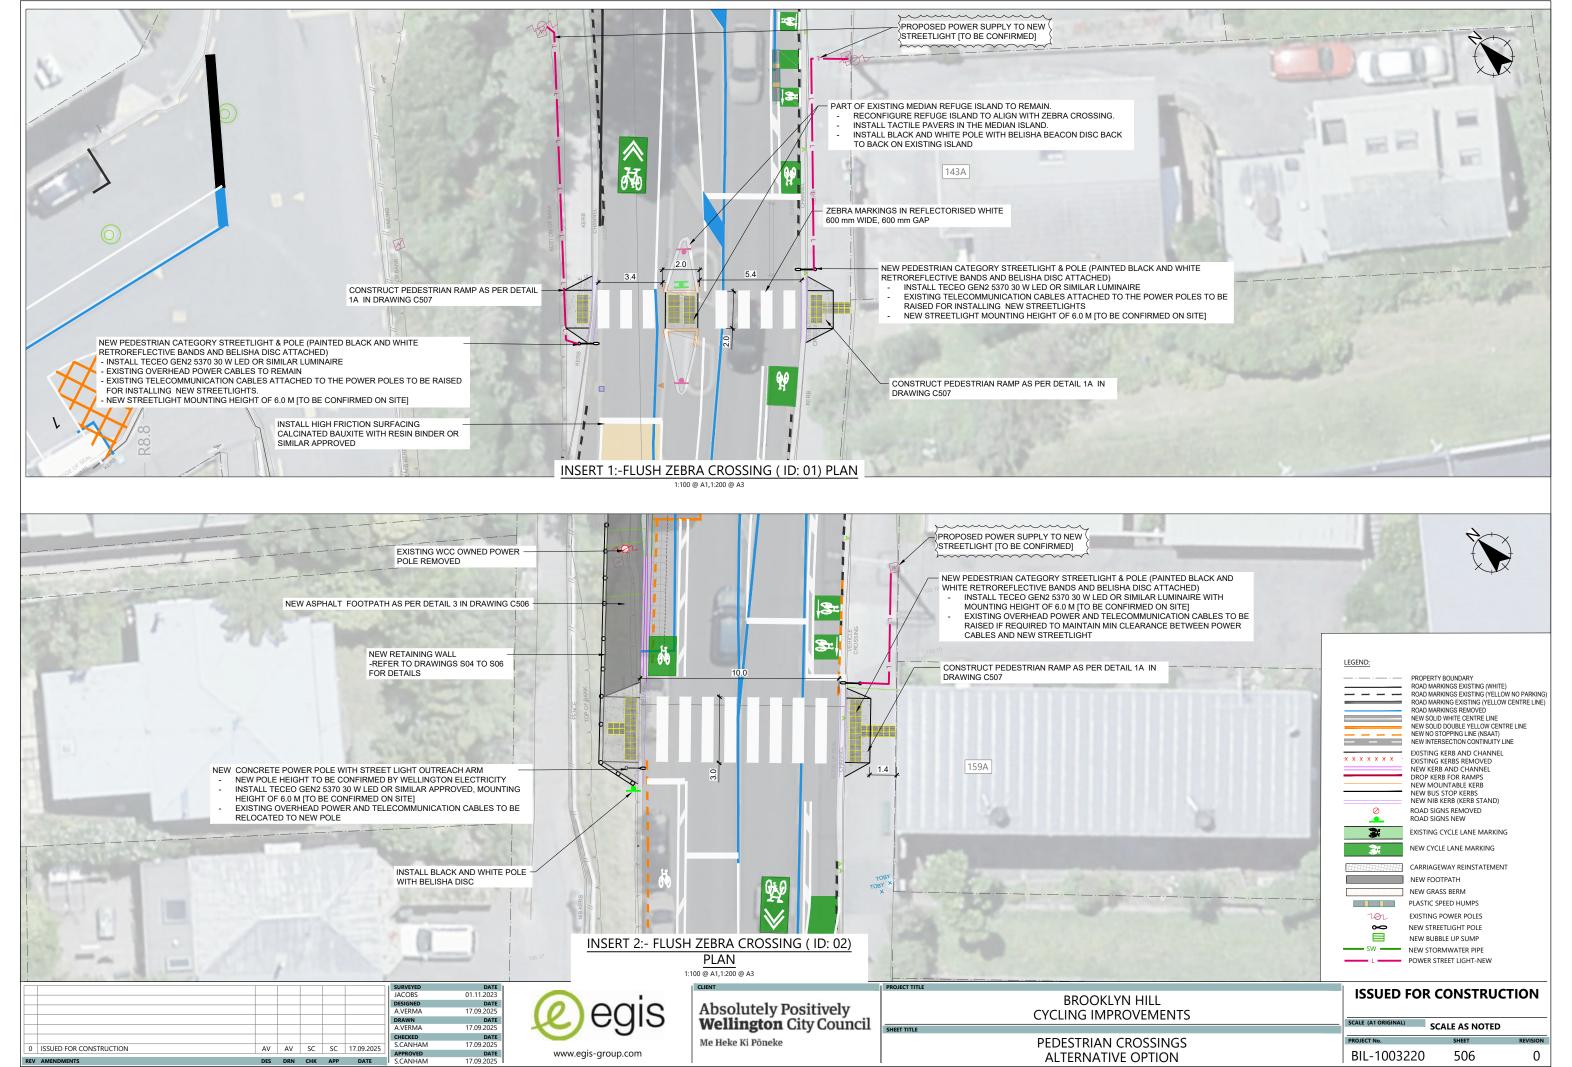


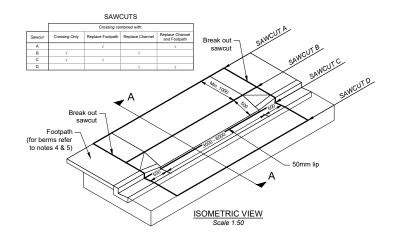


### CROSSING NOTES:


- 1. Where kerb height exceeds 135mm refer to
- 2. 20 MPa (80 -120 slump) concrete with lightly
- 3. Soft subsoils to be undercut by 200mm and filled with compacted basecourse 4. Crossing details shown also apply where no
- 5. Where a grass berm separates the footpath from the kerb, the crossing ramp shall extend from the kerbline to the edge of the adjacent footpath, or 500mm, whichever the greater. The splay length along the kerbline either side of the crossing shall be 500mm.
- 6. \* Refers to heavy duty vehicle crossings

0 ISSUED FOR CONSTRUCTION

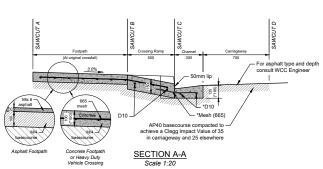

**DETAIL: STD VEHICLE CROSSING** WCC STANDARD DETAIL R-24-721 \ C303

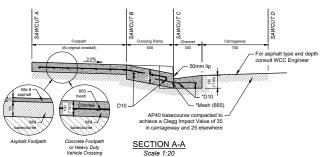

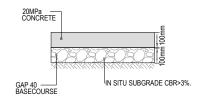

Grade

Conversions

1 in 8 = 12.5%

1 in 10 = 10.0% 1 in 12 = 8.3%

1 in 20 = 5.0%

1 in 40 = 2.5%

1 in 50 = 2.0%

Min. length = 2000mm

OR Max. kerb height (mm) x 12,
whichever is the greater.
To be confirmed by the Engineer

Breakout 700mm

Ramp to match into invert -

Any edge build-up on the carriageway shall be removed to form max. crossfall of 1 in 12

Check this area fo

Reshape channel to max. crossfall grade of 1 in 20. Ramp to match into invert of reshaped channel (ie. no lip)

Pave out as necessary with min. 40mm Mix 10

PLAN

Min. length = 2000mm OR Max. kerb height (mm) x 12,

CROSS SECTION

GENERAL NOTES: (KERBS AND FOOTPATH)

BEHIND KERB FACE.

KERBS WITH VEHICULAR TRAFFIC SHALL BE CONSTRUCTED WITH 30 MPA CONCRETE.

 IF THE SUBGRADE STRENGTH UNDER KERBS OR FOOTPATH DOES NOT MEET THE SPECIFICATIONS PROVIDED IN THE WCC CODE OF PRACTICE FOR LAND DEVELOPMENT, THEN SUBGRADE IMPROVEMENT LAYERS SHALL BE USED.
5. GRANULAR SUB-GRADE IMPROVEMENT LAYERS CAN BE GAP40, GAP65 OR ANY APPROPRIATE MATERIAL WITH CBR >5%, IMPROVEMENT LAYERS SHALL BE

6. ALL BUS STOPS SHALL BE CONSTRUCTED WITH WCC BUS STOP TYPE KERB AND

KERBS TO HAVE MINIMUM 150 MM AP40 BASECOURSE TO EXTENT MINIMUM 200 MM

COMPACTED IN LAYERS WITH LAYERS THICKNESS BEING 2.5 TIMES THE NOMINAL SIZE

The footpath can be lowered to accommodate the max. grade of the kerb ramp

asphalt concr

as directed by the Engineer

1 in 8 approx.

60mm thick tactile

DETAIL: PEDESTRIAN RAMP (1A)

WCC STD DETAIL R-24-727

on 40mm thick 2:1

DETAIL: ASPHALT FOOTPATH PAVEMENT 3

AP 40——BASECOURSE



DETAIL: CONCRETE FOOTPATH PAVEMENT 4



Directional indicators if specifically directed by the Engineer. These shall be aligned with the intended direction of travel of the pedestrian, as

Area may have to be lowered and extended to achieve grade requirements of kerb ramp and transition to abutting pavement

The tactile pavers shall be aligned with the intended direction of travel of the

pedestrian, as directed by


- D12 reinforcing bar

Lip of channel

directed by the Enginee


1 in 8 approx


- Tactile surfaces will normally be 60mm thick yellow concrete tiles laid on a 40mm thick 2:1 sand/cement bed. Any alternative materials shall be
- 2) The tactile pavers should not be stepped in groups (unless agreed by the Engineer).
- Kerb ramp to comply to NZS 4121 Design for Access & Mobility Buildings & Associated Facilities
- 4) Tactile surface to comply with LTSA RTS-14.
- 5) Directional indicators will normally be required in shopping and commercial areas and where the footpath is located away from the kerb and channel. 6) Tactile pavers setout to be approved by the Engineer on site prior to installation

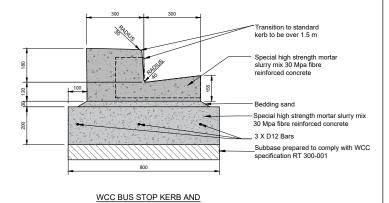



CHANNEL

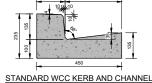

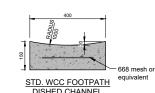





STD WCC NIB

DETAIL: WCC STD KERBS

## 17.09.2025 www.egis-group.com

Absolutely Positively **Wellington** City Council Me Heke Ki Pôneke

STANDARD DETAILS

**BROOKLYN HILL** CYCLING IMPROVEMENTS

SHEET 1 OF 6

**ISSUED FOR CONSTRUCTION** SCALE AS NOTED

0

BIL-1003220

AV AV SC SC 17.09.2025


DES DRN CHK APP DATE S.CANHAM

IN SITU SUBGRADE CBR>3%.

Egis Title Block Version

### NOTE:


- 1. ALL DIMENSIONS IN METRES UNLESS NOTED OTHERWISE.
- 2. ALL BUFFERS BE CONSTRUCTED AS EXTRUDED FIBRE REINFORCED CONCRETE BUFFERS IN ACCORDANCE WITH WCC COP STANDARDS FOR KERBS, SECTION C.2.4.

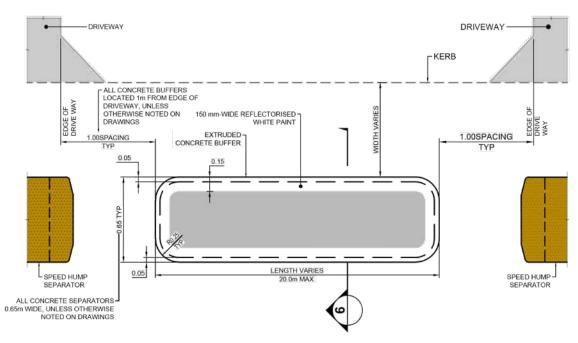

TYPICAL EXTRUDED CONCRETE BUFFER -PLAN


DETAIL SUPPLIED BY WCC
NTS

OTHER PROPERTY OF THE PROP

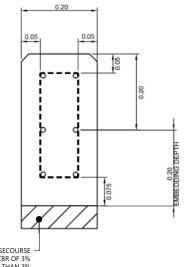


75 mm THICK AP40 BASECOURSE — MIN SUB-GRADE CBR OF 3% IF SUBGRADE IS LESS THAN 3% RIP AND REPLACE POOR SUBGRADE WITH 200 mm THICK GAP65 SUB-BASE




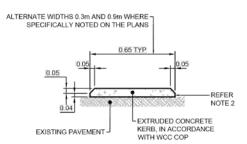

EXTRUDED BUFFER SECTION 6

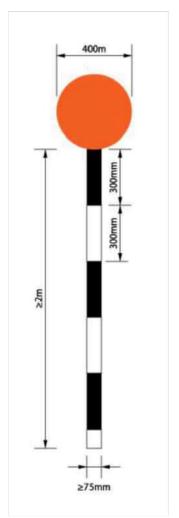


BELISHA BEACON 8

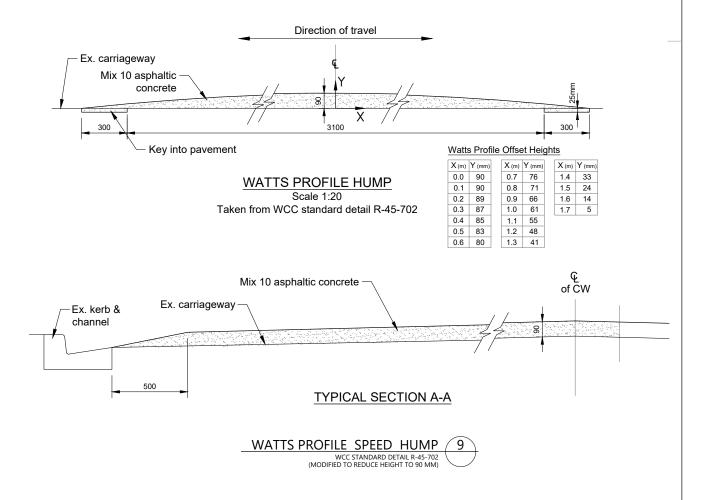




Absolutely Positively **Wellington** City Council Me Heke Ki Pôneke


PROJECT TITLE  BROOKLYN HILL	ISSUED FOR	R CONSTRUCT	ΓΙΟΝ
CYCLING IMPROVEMENTS SHEET TITLE	SCALE (A1 ORIGINAL)	SCALE AS NOTED	ALWAYS CHECK SCALE
STANDARD DETAILS	PROJECT No.	SHEET	REVISION
SHEET 2 OF 6	BIL-1003220	508	0

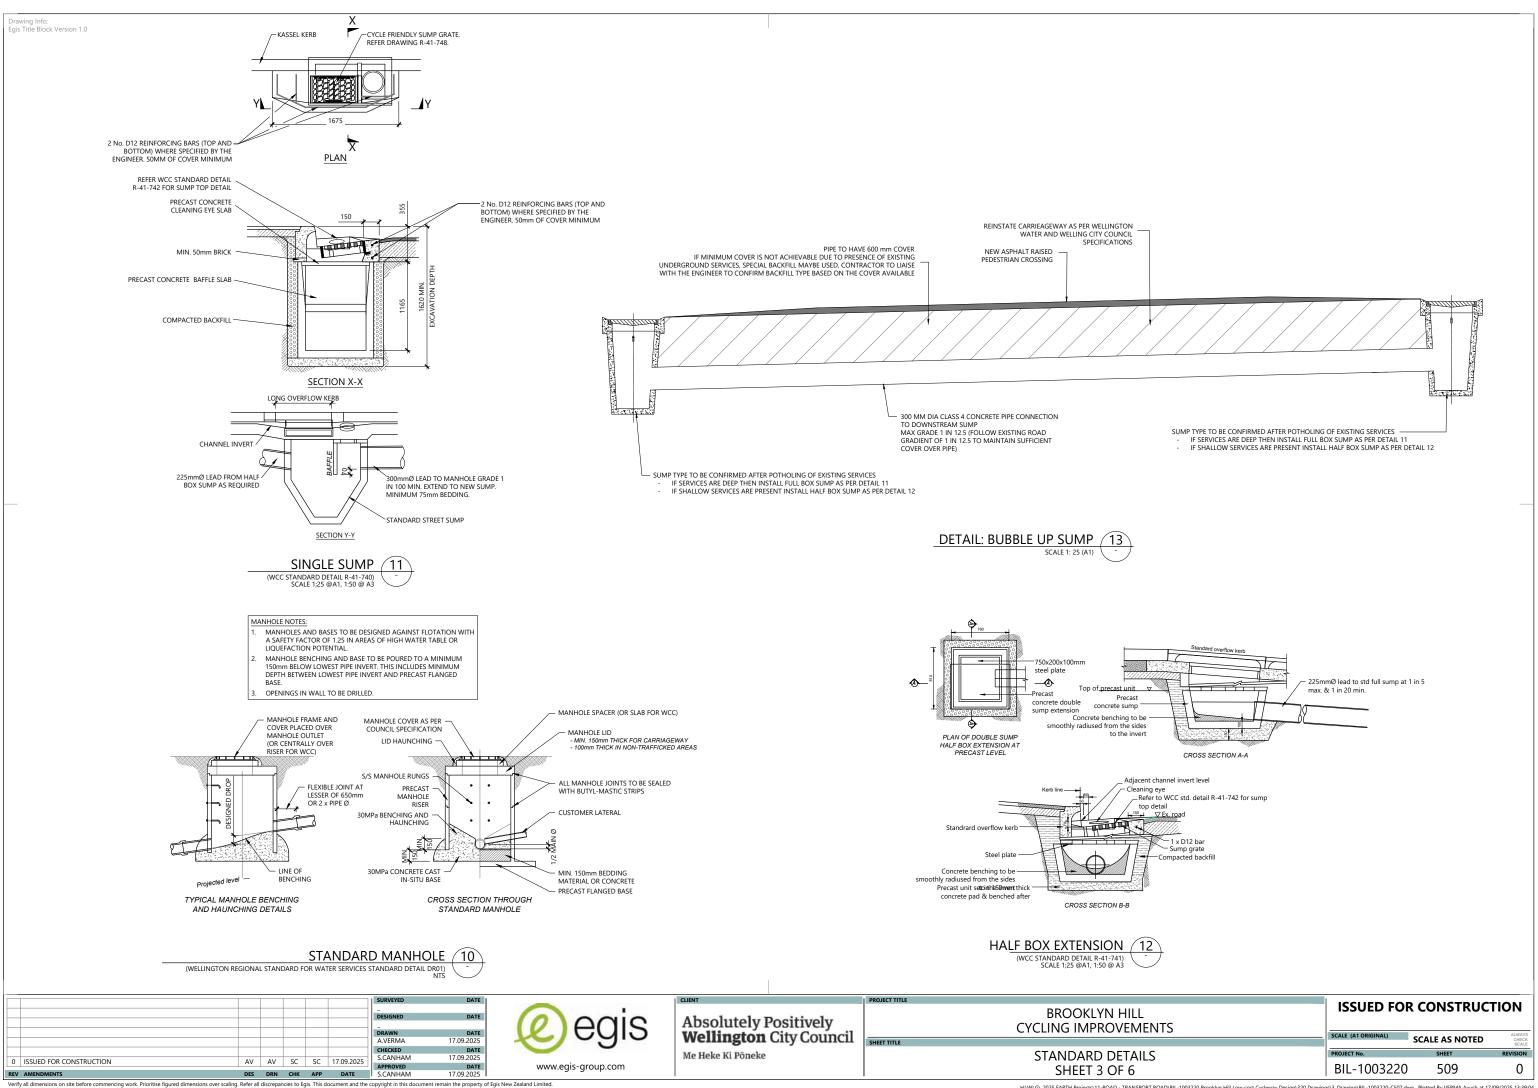

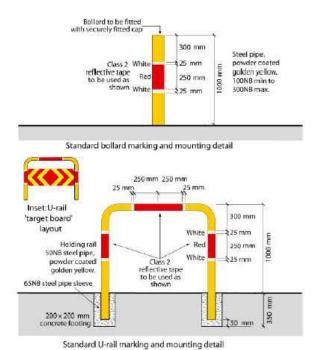

Details of a bollard and U-rail from Austroads Part 6A, Figure 7.10.


STANDARD U-RAIL (HOLD RAIL) 15

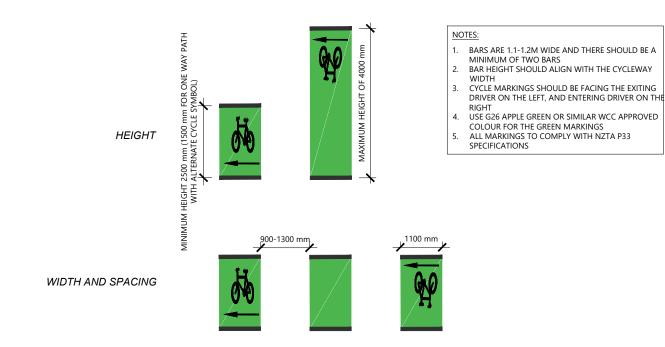

DETAIL: HIGH USE DRIVEWAY MARKING 17 1:25 (A1) NZTA GUIDANCE NOTE

> 100mm THICK 20MPa CONCRETE BASE WITH STEEL MESH 665

BASECOURSE

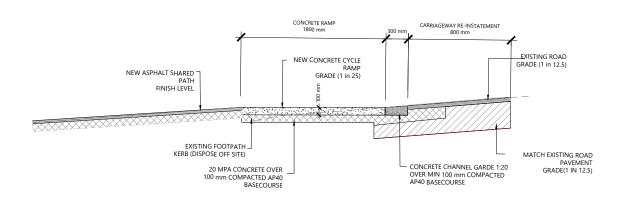


TYP SECTION: RAMP ON STEEP GRADES 14


17.09.2025 0 ISSUED FOR CONSTRUCTION AV AV SC SC 17.09.2025 DES DRN CHK APP DATE S.CANHAM






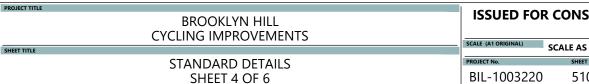


TO BE CONFIRMED

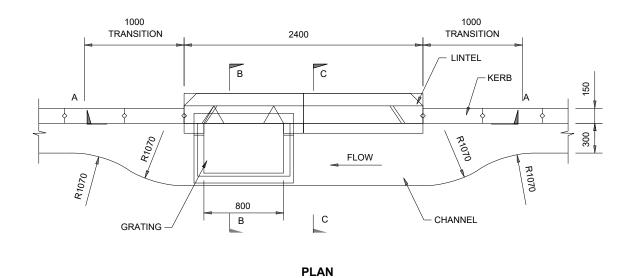


Scale: NTS

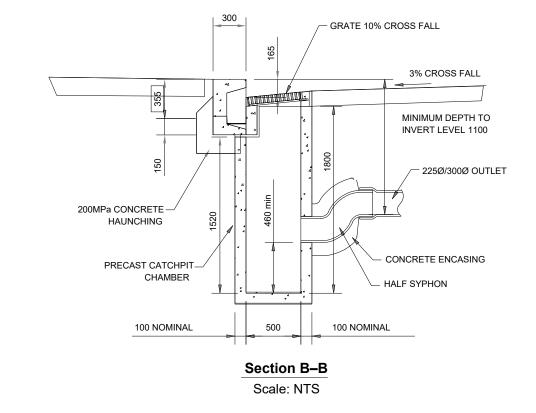

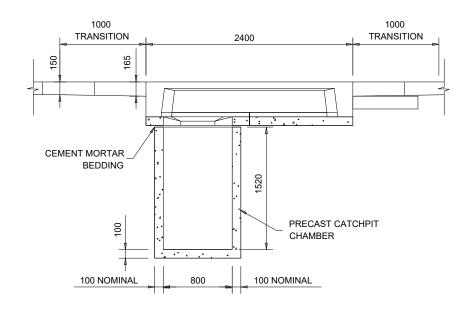

SECTION A - A

Scale: NTS

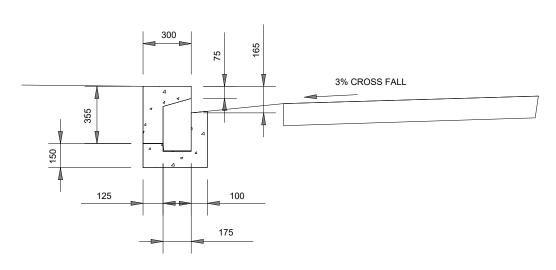

Section C-C Scale: NTS


HYNDS STREE CATCHPIT 18

17.09.2025 0 ISSUED FOR CONSTRUCTION AV AV SC SC 17.09.2025




Absolutely Positively **Wellington** City Council Me Heke Ki Pôneke


l	PROJECT TITLE	1661155 505		
	BROOKLYN HILL CYCLING IMPROVEMENTS	ISSUED FOR	R CONSTRUCT	ION
ı		SCALE (A1 ORIGINAL)	SCALE AS NOTED	ALWAYS CHECK
ı	SHEET TITLE		SCALE AS NOTED	SCALE
I	STANDARD DETAILS	PROJECT No.	SHEET	REVISION
	SHEET 5 OF 6	BIL-1003220	511	0

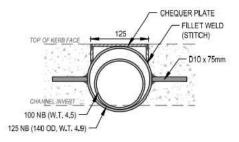

## FRONT ELEVATION

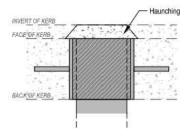


## PLAN VIEW

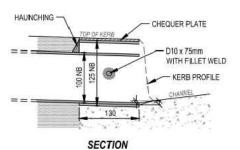


NOTES: 1. CONCRETE TO BE 20MPa.

TO BE USED ONLY WHERE POSSIBILITY OF FLOODING OF PIPE WILL NOT CAUSE SUBSEQUENT PROPERTY DAMAGE.

DETAIL : KERB OUTLET 19 SUPPLIED BY WCC

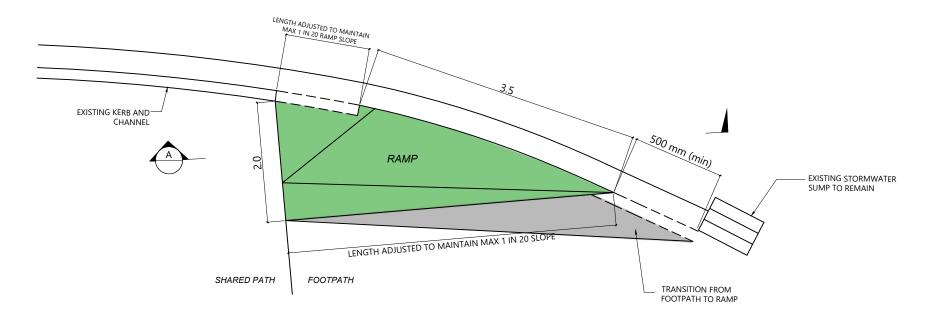

## PLAN (NTS)

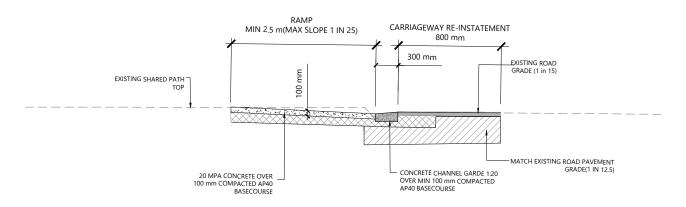

## CROSS SECTION A-A (NTS)


DETAIL : CYCLE RAMP UPHILL 20


							SURVEYED	DATE
							_	
							DESIGNED	DATE
1								DATE
							DRAWN	
							A.VERMA	17.09.2025
							CHECKED	DATE
0	ISSUED FOR CONSTRUCTION	AV	AV	SC	SC	17.09.2025	S.CANHAM	17.09.2025
	1330ED FOR CONSTRUCTION	7.4	/\v	JC	50	17.05.2025	APPROVED	DATE
REV	AMENDMENTS	DES	DRN	СНК	APP	DATE	S.CANHAM	17.09.2025


<u>e</u>	egis
www.eg	is-group.com


CLIENT
Absolutely Positively <b>Wellington</b> City Council
Me Heke Ki Pôneke


	BROOKLYN HILL CYCLING IMPROVEMENTS	ISSUED FOR	R CONSTRUCT	ΓΙΟΝ
l	SHEET TITLE	SCALE (A1 ORIGINAL)	SCALE AS NOTED	ALWAYS CHECK SCALE
	STANDARD DETAILS	PROJECT No.	SHEET	REVISION
	SHEET 6 OF 6	BIL-1003220	512	0

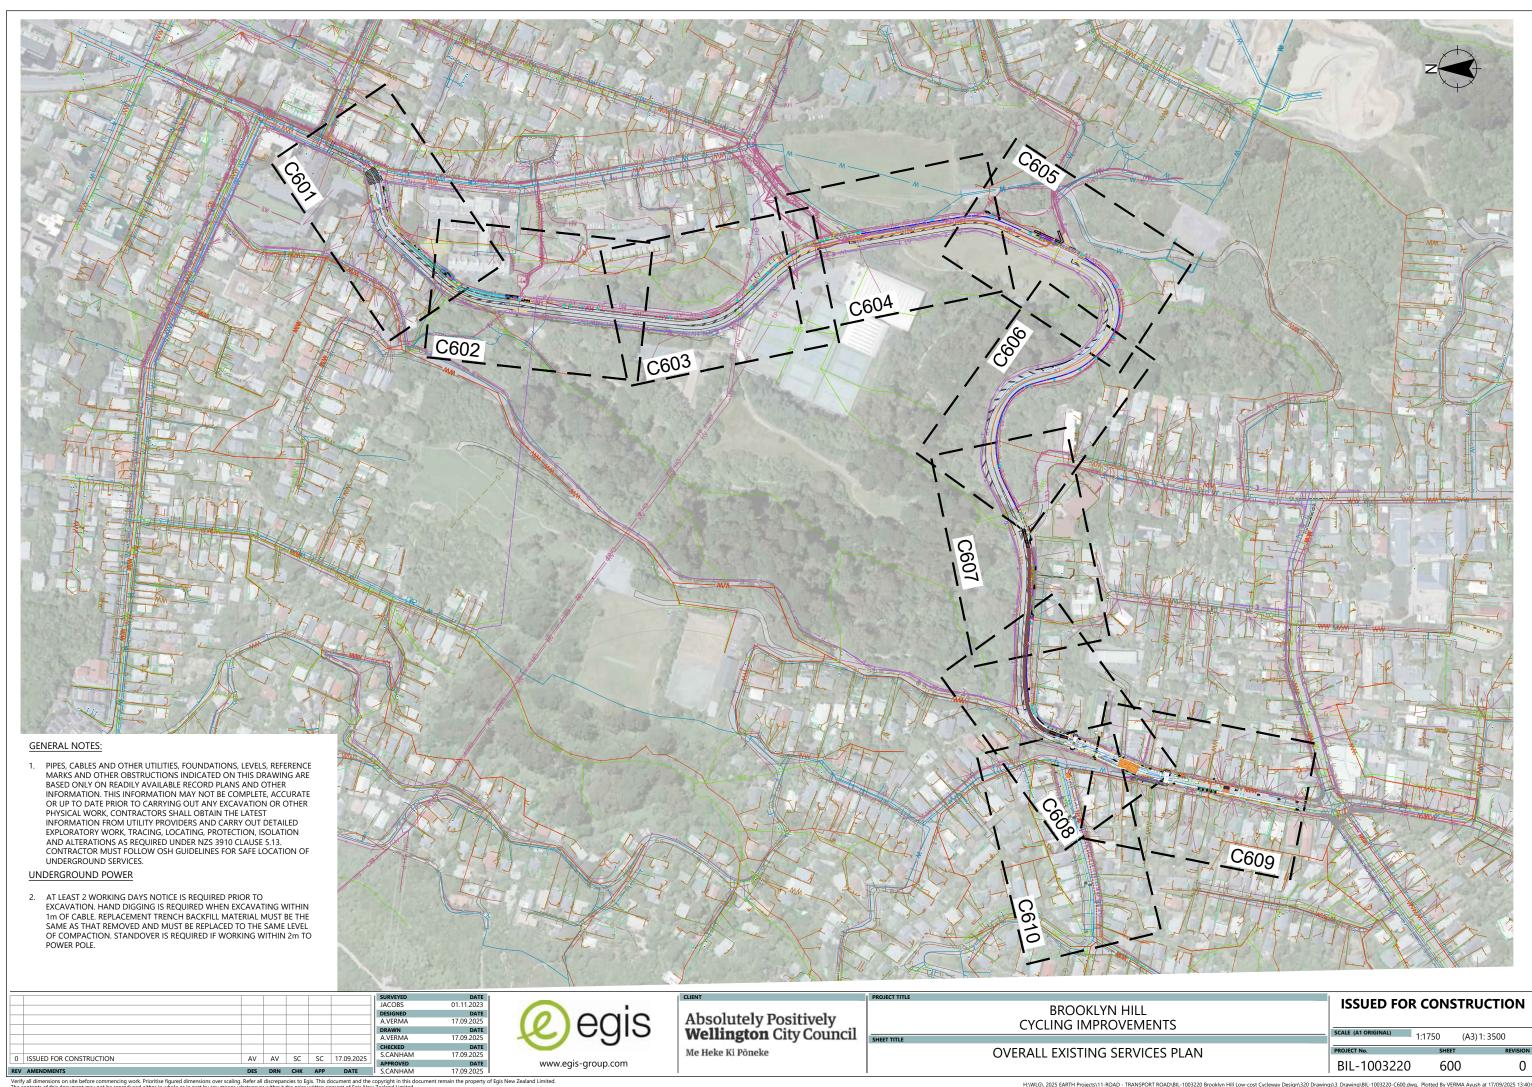


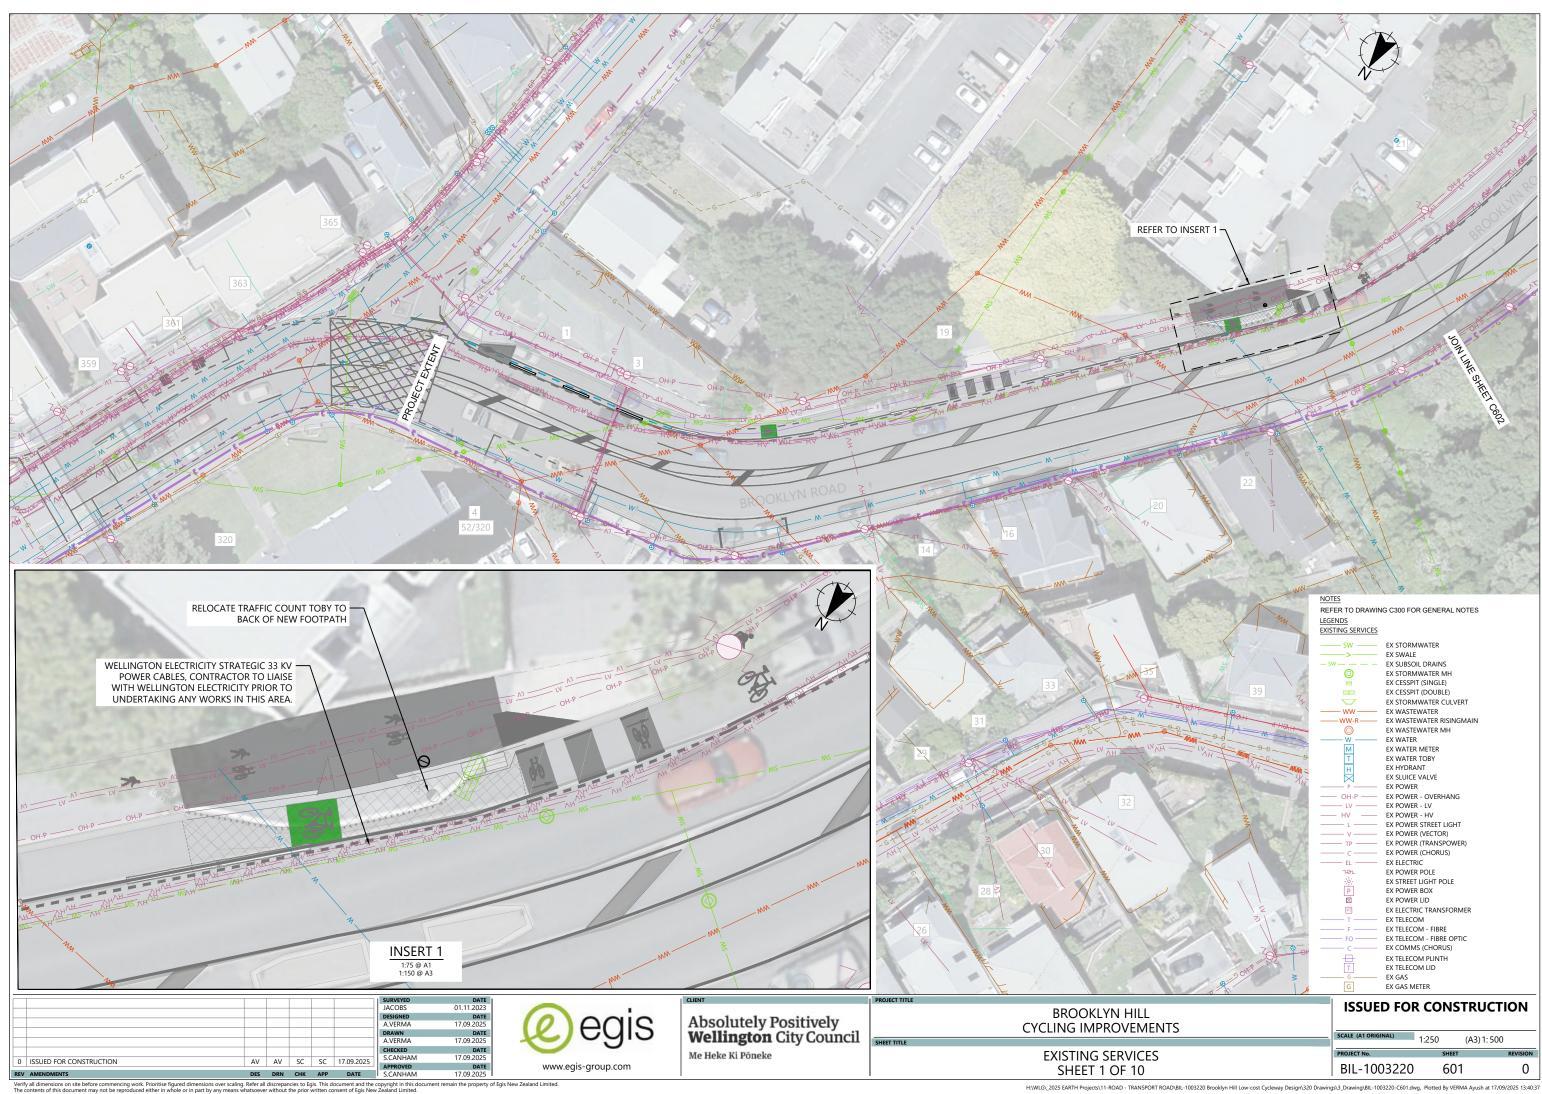


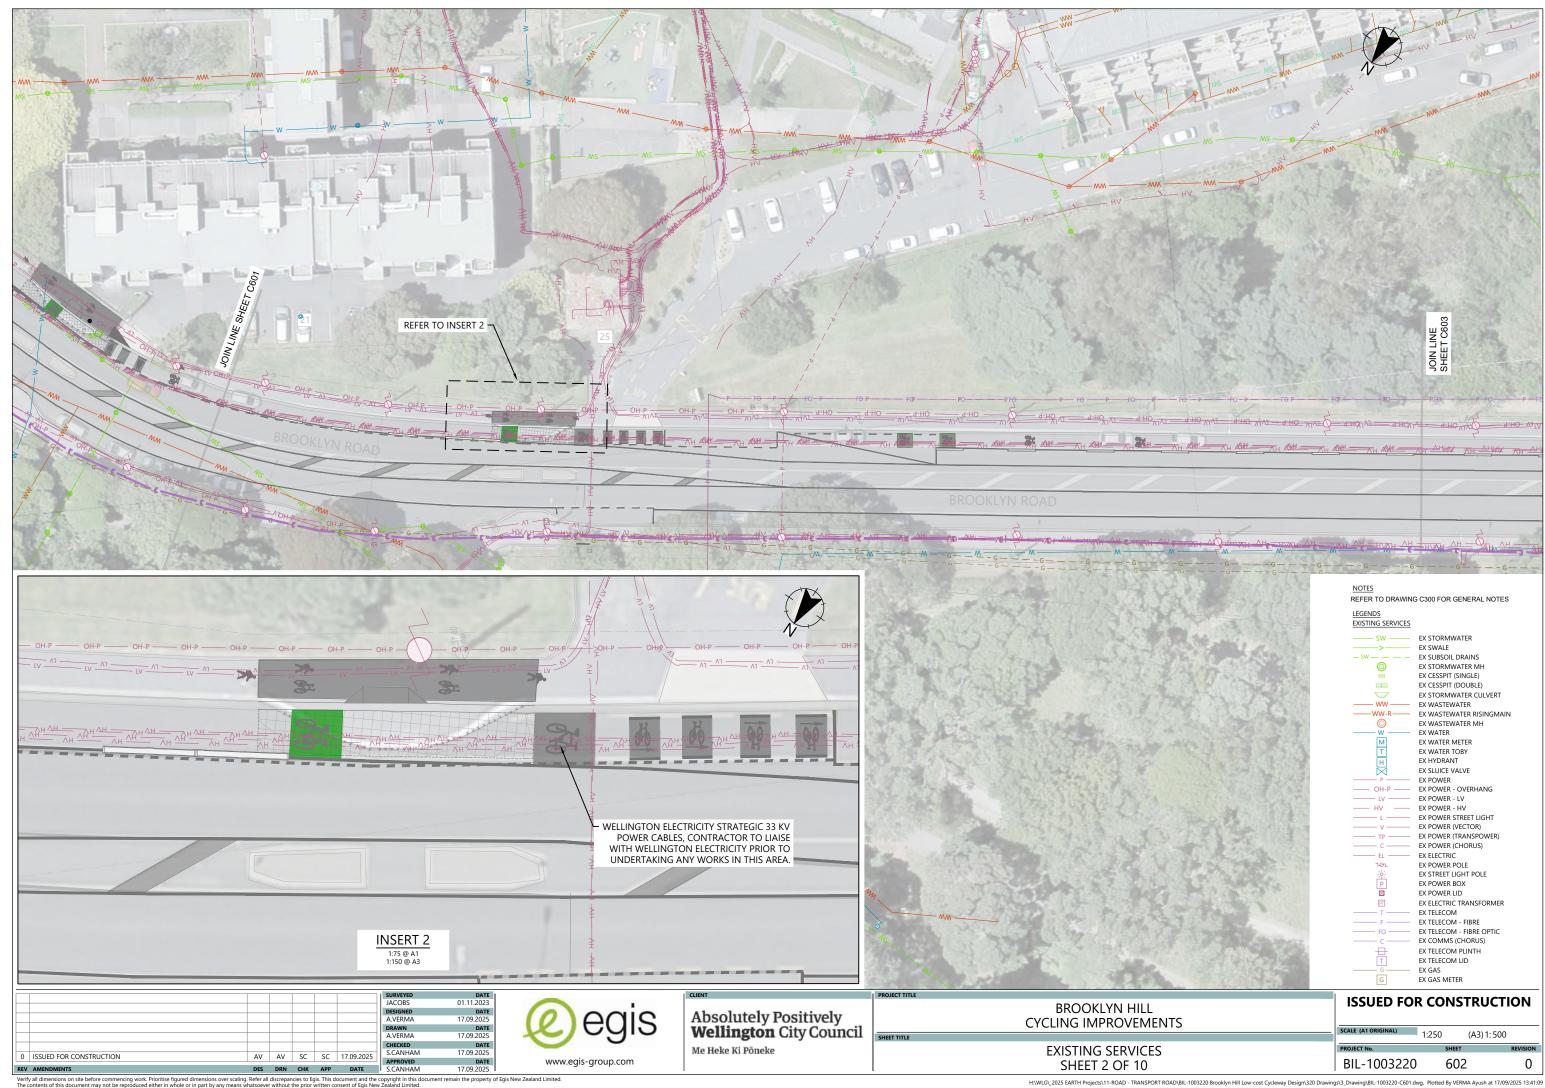


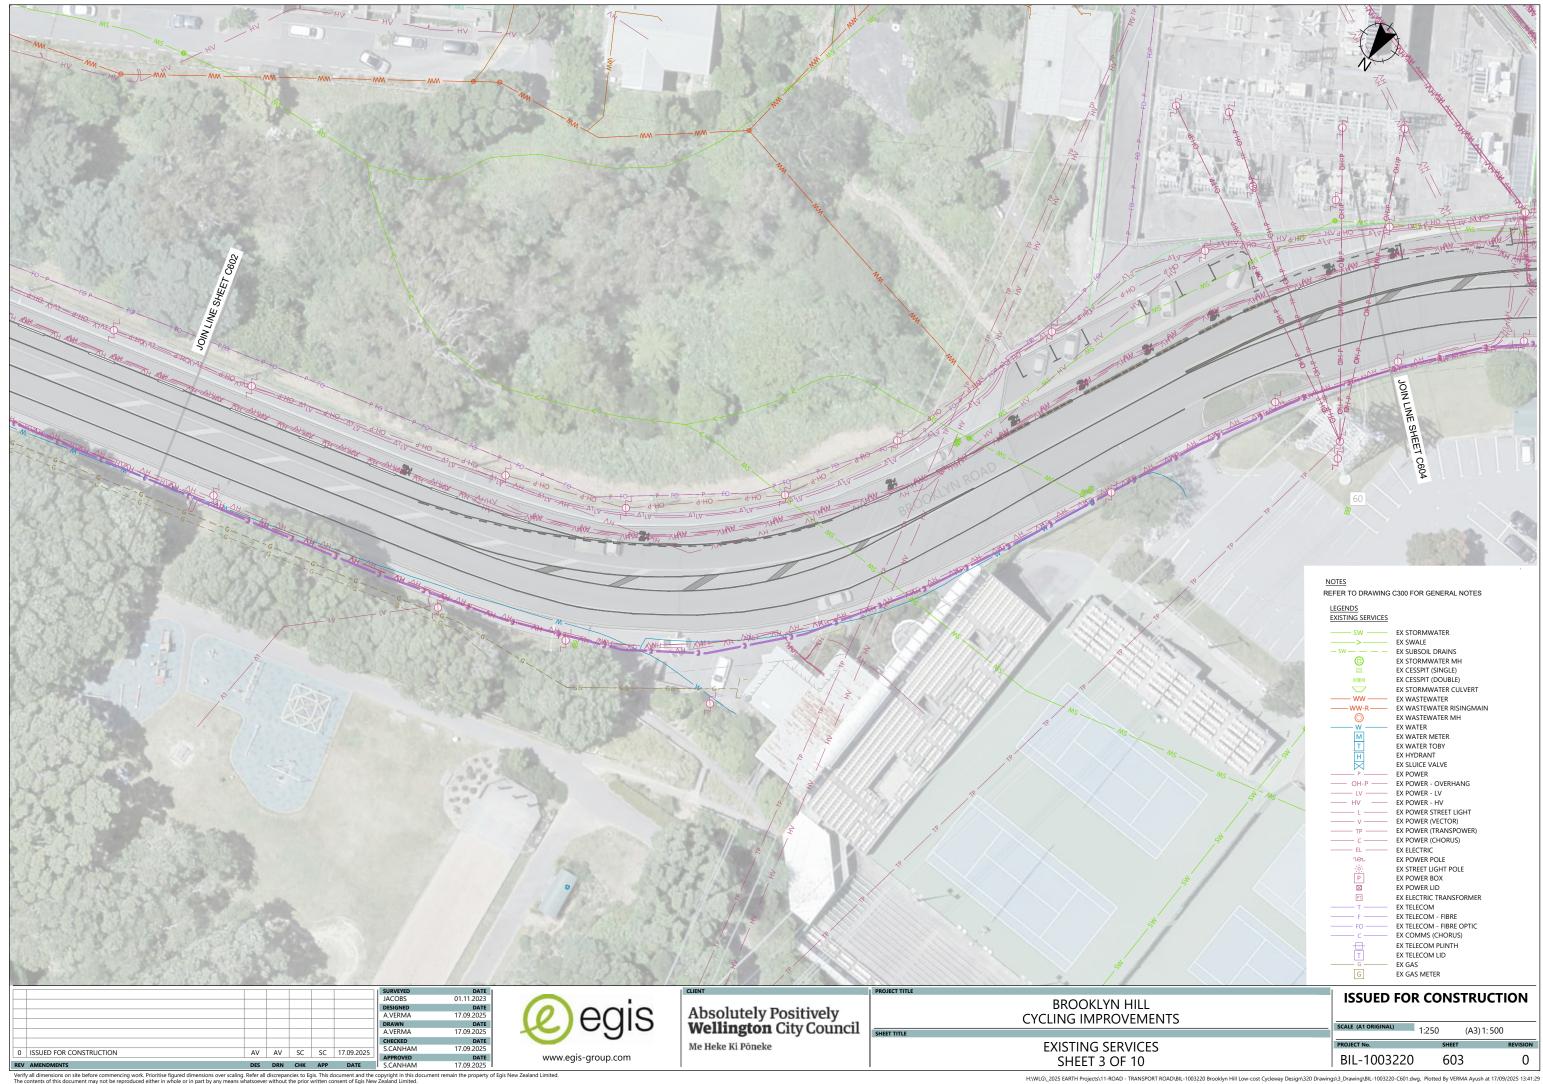


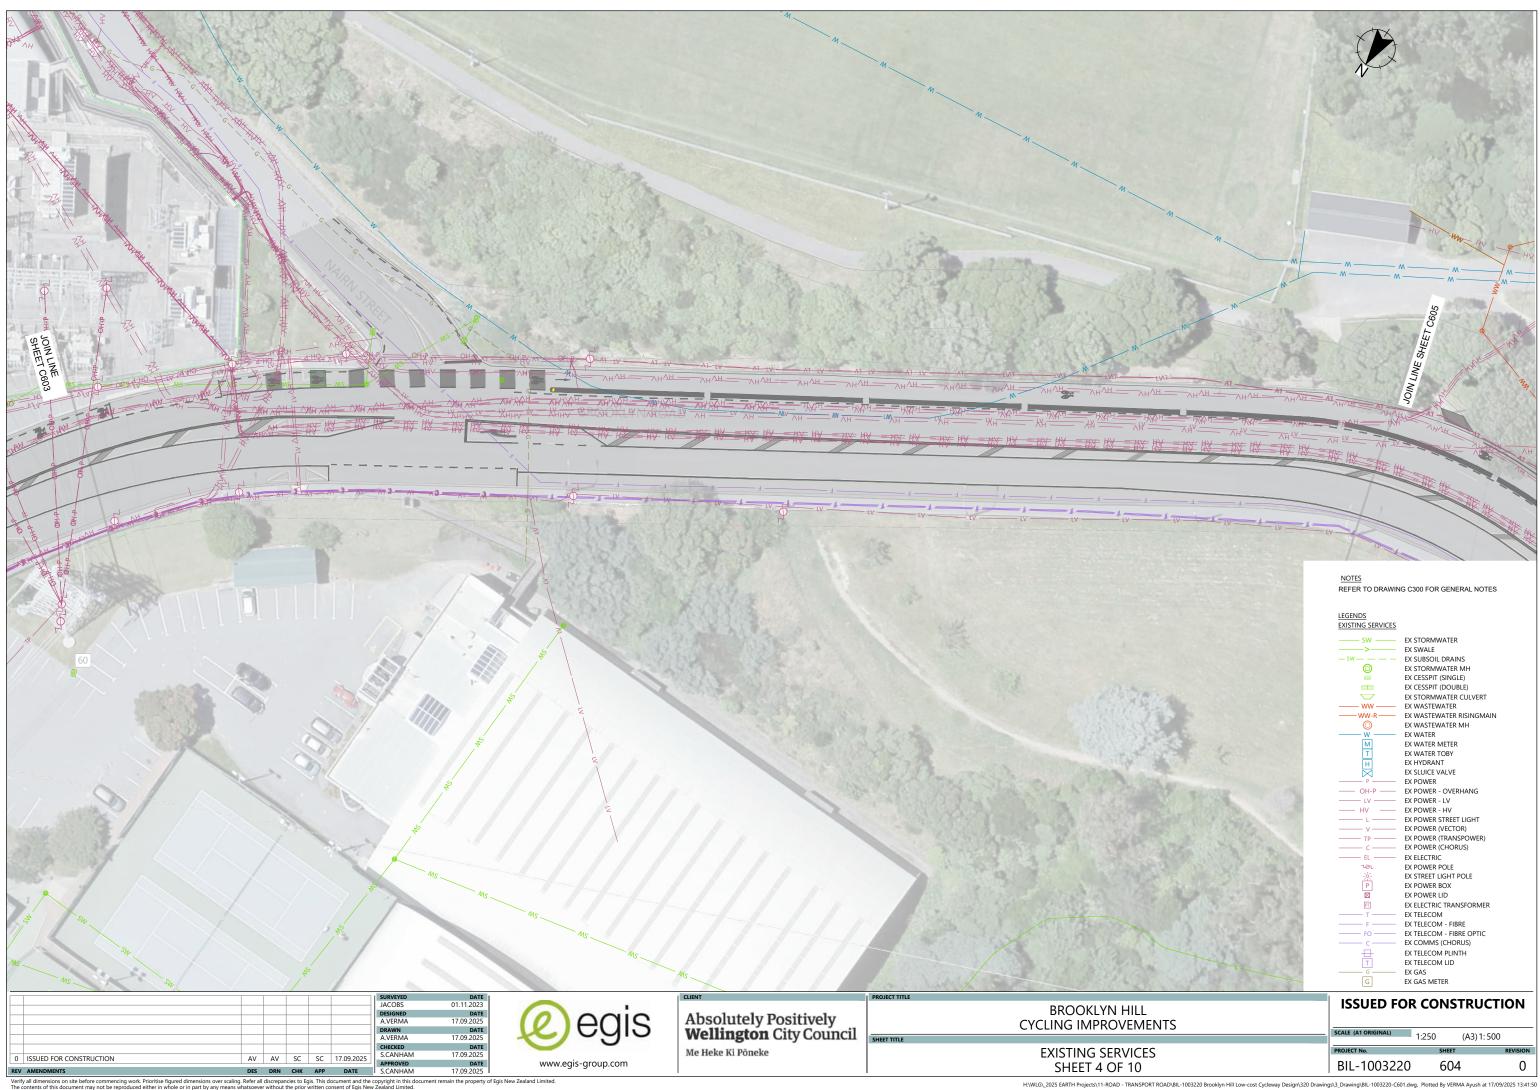


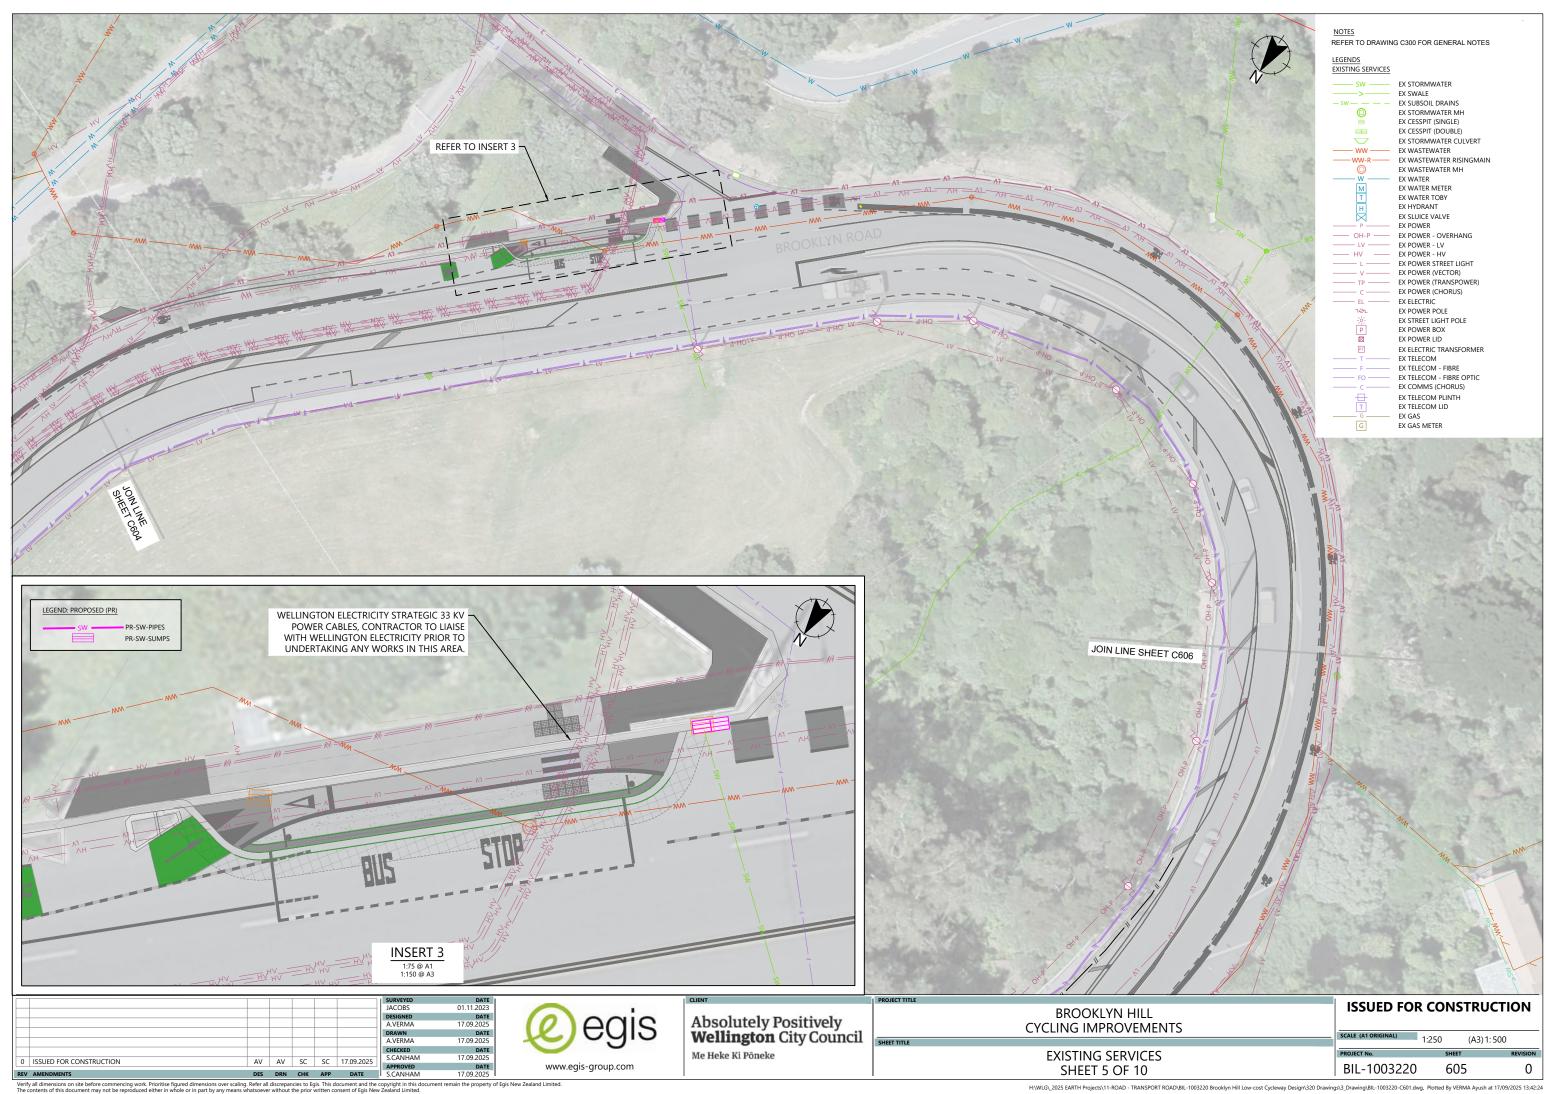


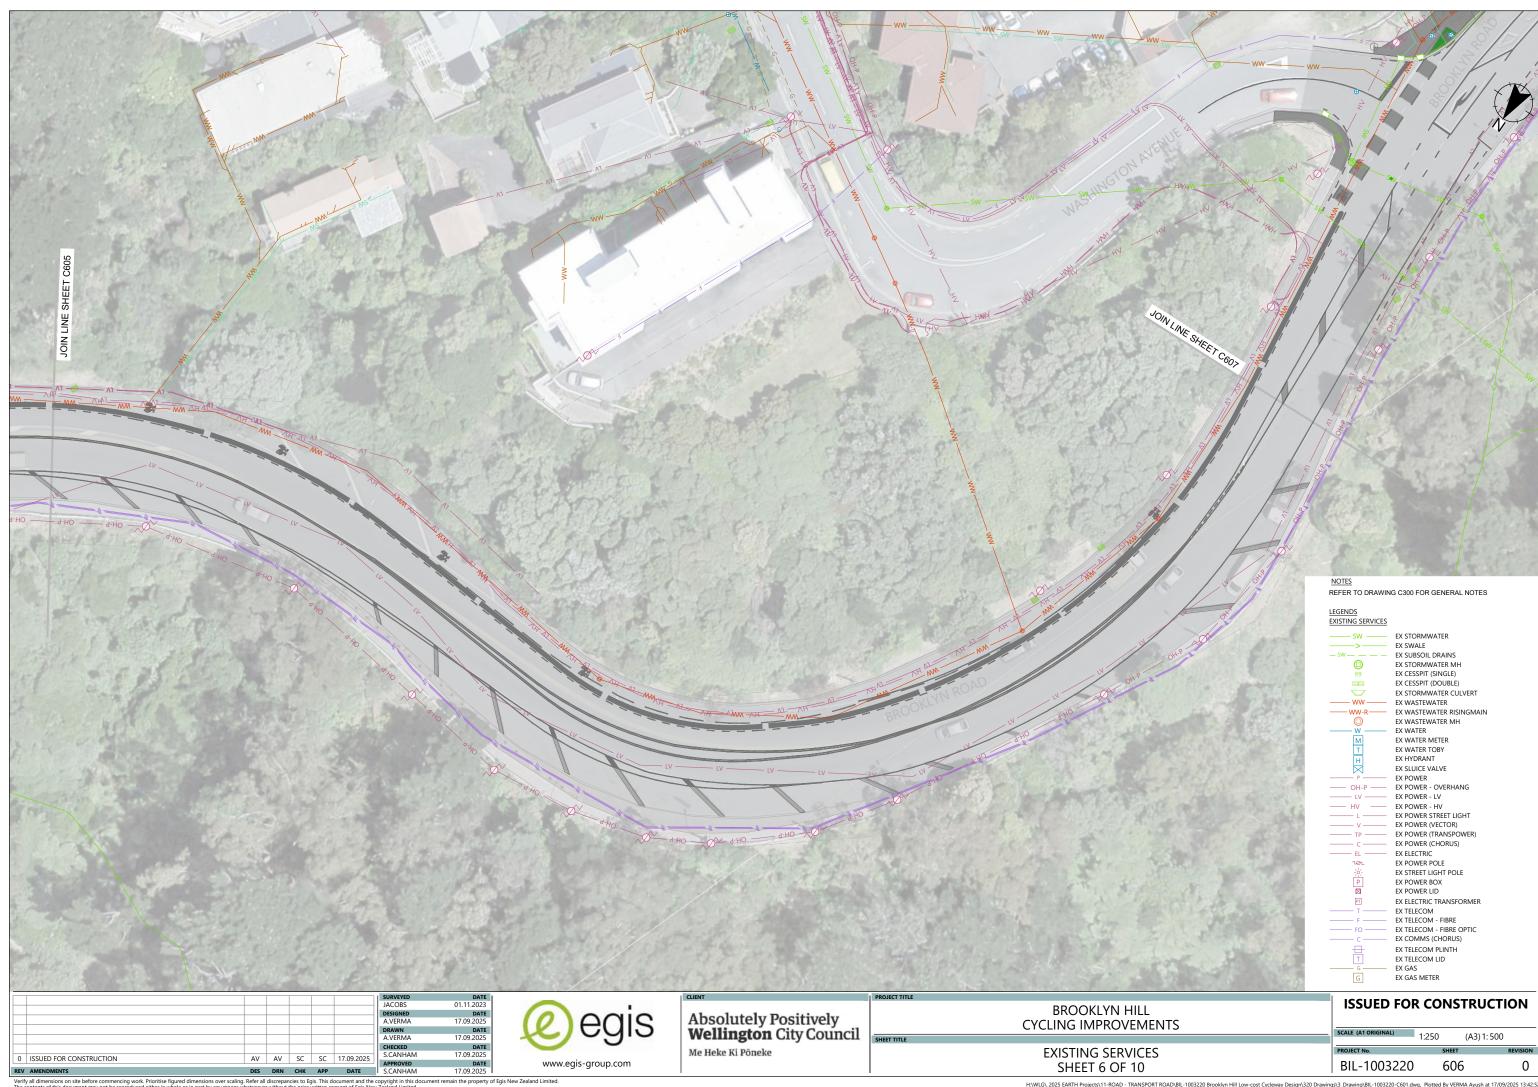


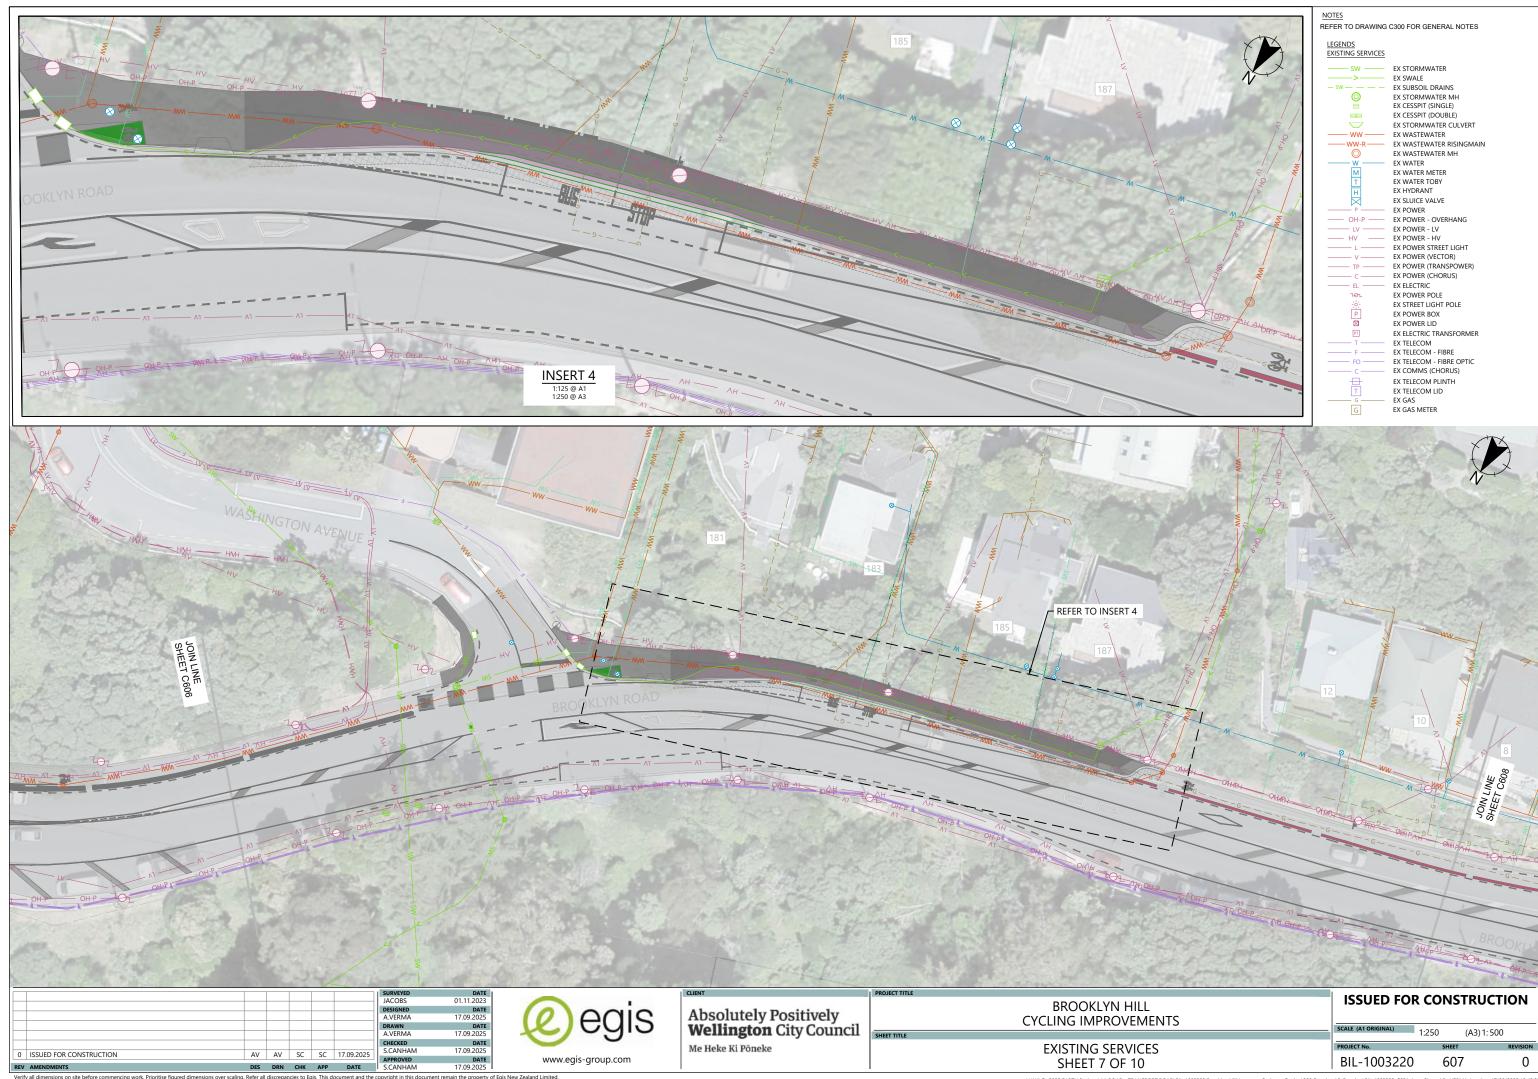

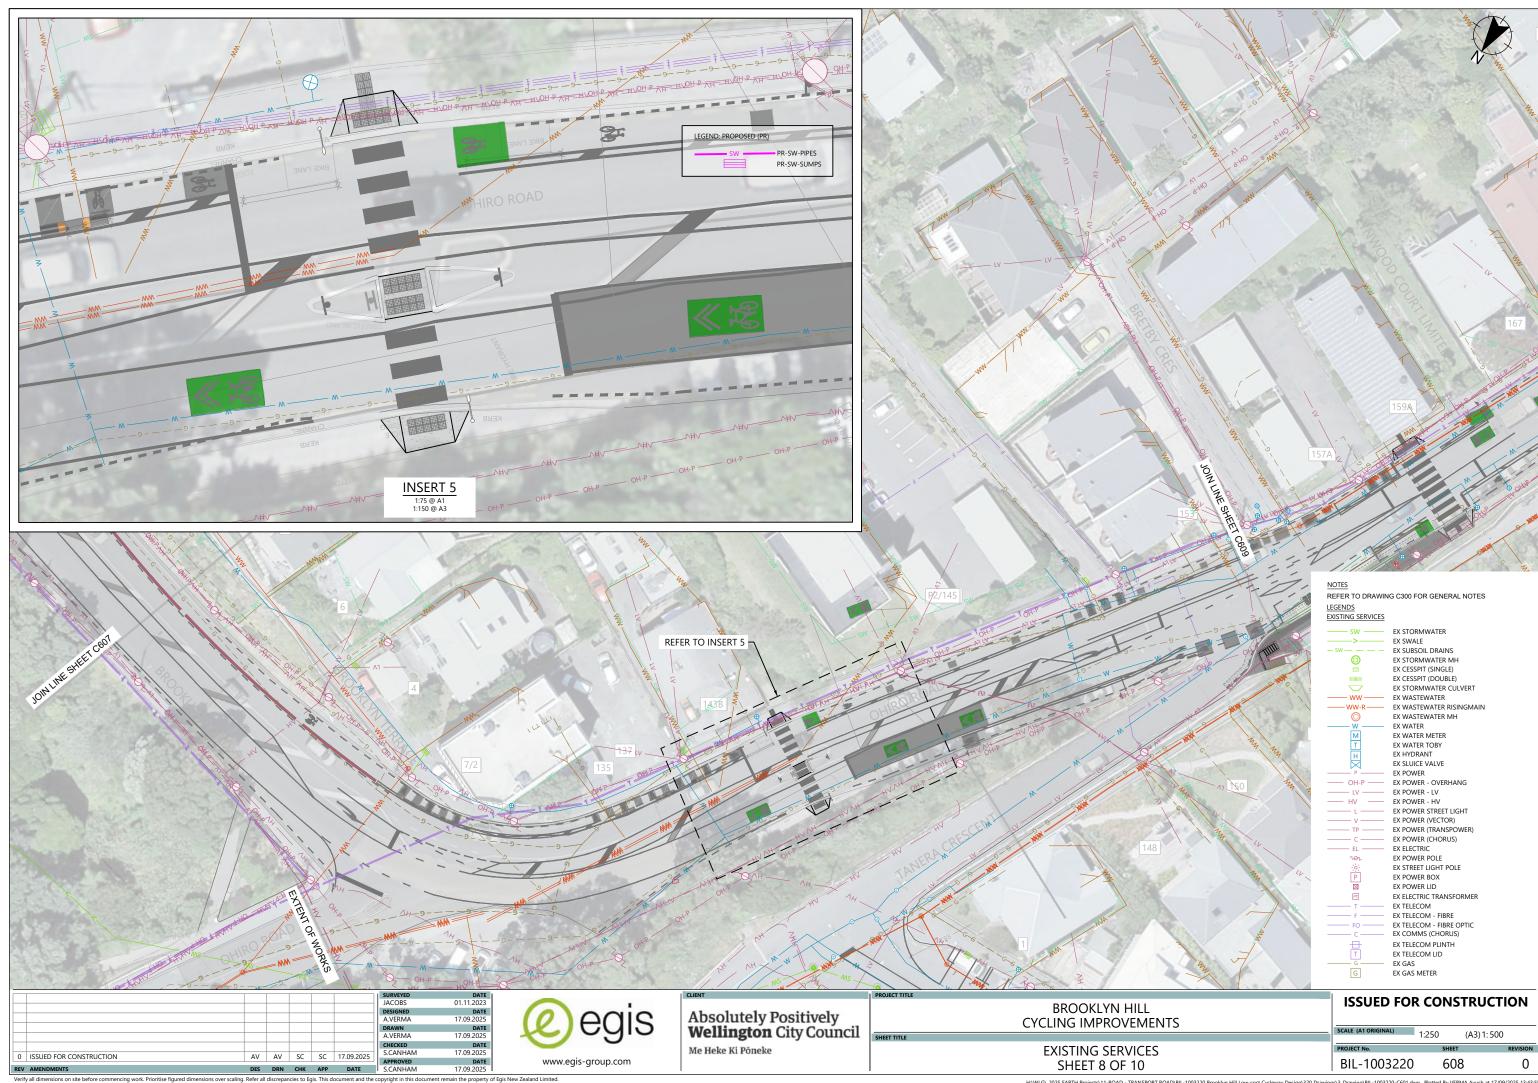

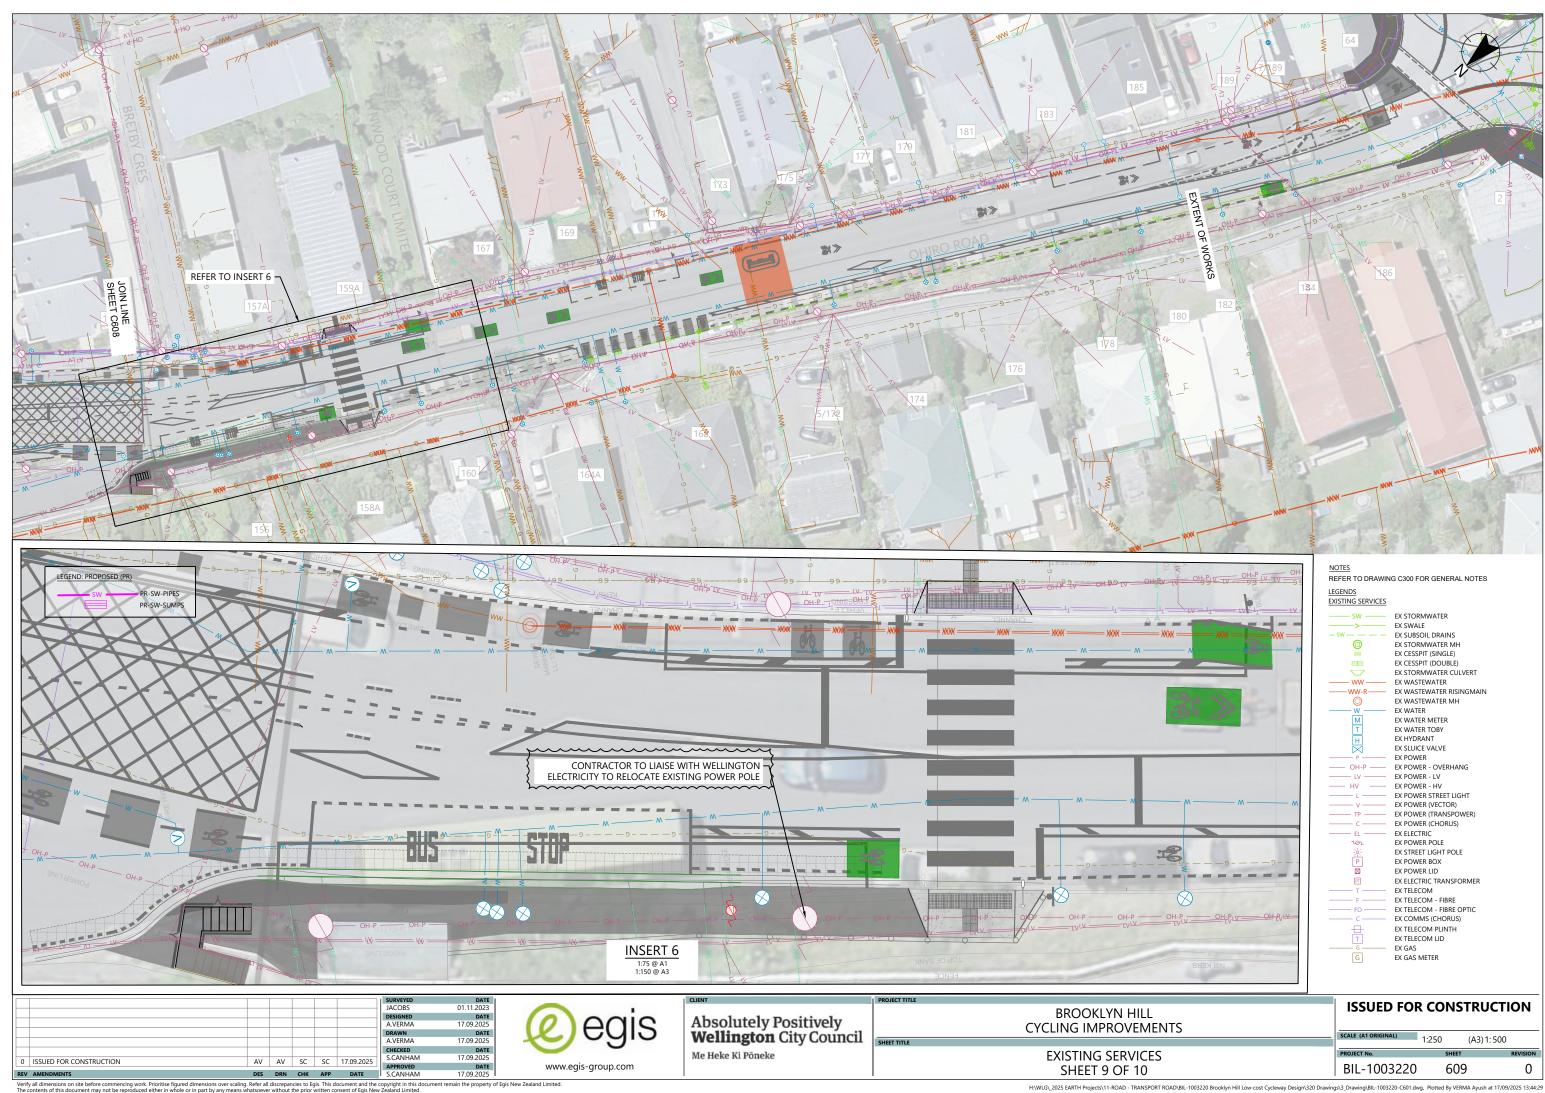

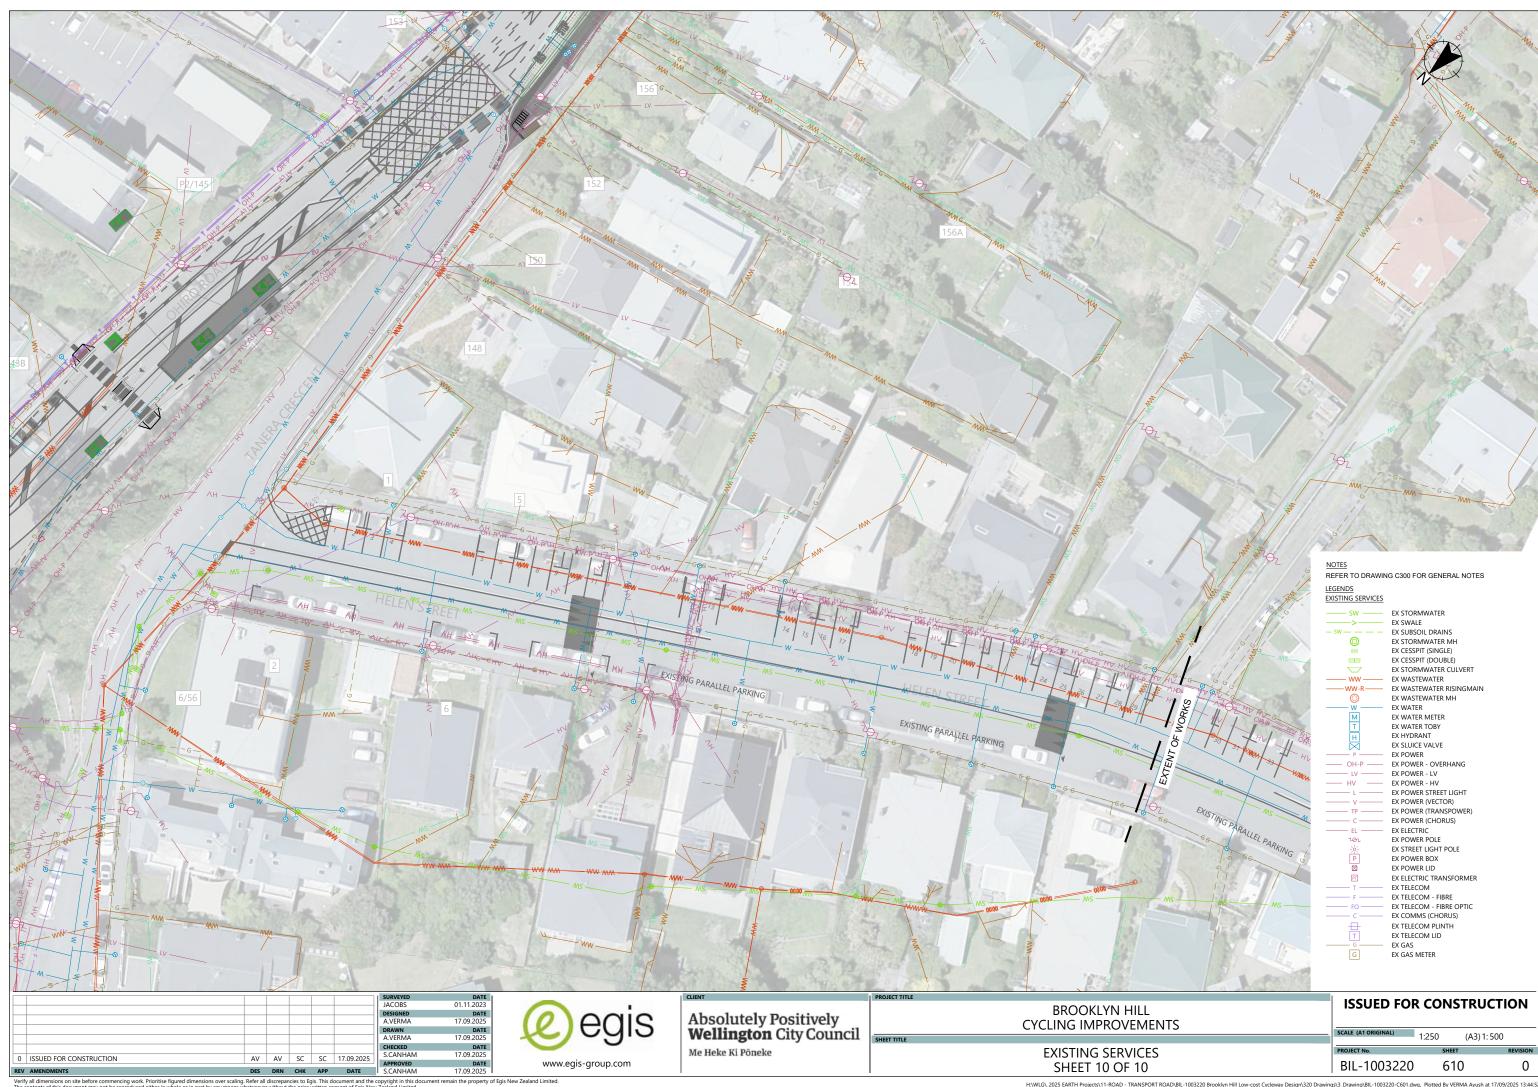

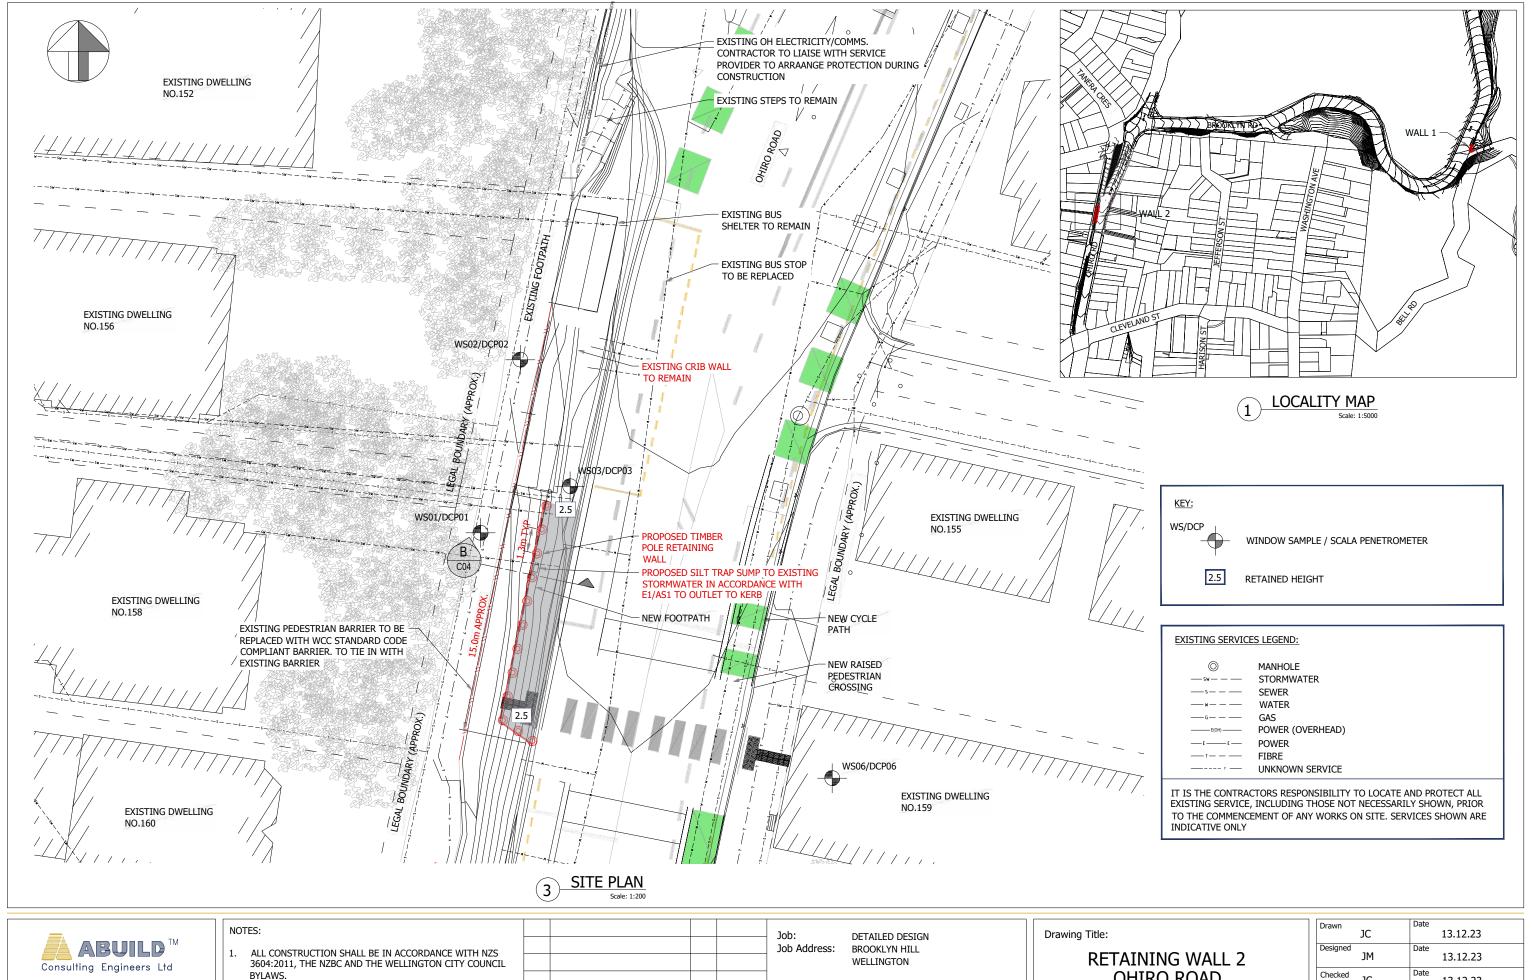



Member of the Association of Consulting Engineers NZ

Box 13 273 Johnsonville Wellington Phone (04) 478 3929

ALL DIMENSIONS SHALL BE CONFIRMED ON SITE PRIOR TO ORDERING MATERIALS, ALL VARIATIONS TO THE DIMENSIONS ON THE DRAWINGS SHALL BE REFERRED TO THE DESIGNER.

CONFIRM THE LOCATIONS OF ALL SERVICES WITH SERVICE OWNERS PRIOR TO THE START OF CONSTRUCTION.

				Job
				Job
				Clie
В	PROPOSED BARRIER	JM	28.02.24	
Α	DETAILED DESIGN	JC	13.12.23	
Rev	Revision Details	Ву	Date	

WELLINGTON CITY COUNCIL

OHIRO ROAD **LOCALITY & SITE PLAN** 


JC JC	13.12.23
Designed JM	Date 13.12.23
Checked JC	Date 13.12.23
Approved SG	Date 13.12.23

Scale: AS SHOWN @ A3

Job No	Sheet
14565	S04

## WALL 2 DETAILS

- 1. ENGINEER TO CHECK POLE HOLES AND CONFIRM GROUND CONDITIONS WHEN OPENED UP
- FOR HOLES ON SLOPING GROUND MEASURE EMBEDMENT DEPTH FROM DOWNSLOPE LIP OF HOLE WHERE APPROPRIATE
- POLES TO BE PLACED WITH THE LARGER DIAMETER END IN THE GROUND
- FOR ORDERING PURPOSES THE SUPPLIER REQUIRES THE POLE SMALL END DIAMETER. VALUES GIVEN BELOW ASSUME A TYPICAL POLE TAPER OF 5mm PER METRE. HOWEVER AS TAPER MAY VARY THE BUILDER MUST ENSURE THE CORRECT DIAMETER IS ACHIEVED AT GROUND LEVEL. THIS WILL BE CHECKED BY THE
- ANY OVALITY IN A POLE SHOULD BE POSITIONED WITH THE LARGER DIMENSION PERPENDICULAR TO THE WALL
- THE BUILDER IS RESPONSIBLE FOR IDENTIFYING AND LOCATING ANY UNDERGROUND SERVICES THAT MIGHT AFFECT THE WORK
- THE BUILDER IS RESPONSIBLE FOR THE SAFETY OF THE WORK, ESPECIALLY THE COVERING OF OPEN HOLES, AND SHALL COMPLY WITH THE HEALTH AND SAFETY AT
- COMPLY WITH THE BUILDING CODE AND TERRITORIAL AUTHORITY REQUIREMENTS
- CONTACT ABUILD FOR FURTHER INFORMATION IF REQUIRED, INCLUDING:
- 10. ALTERNATIVE SPACINGS TO SUIT POLE SIZE DISCREPANCIES ON SITE OR SMALLER
- 11. FINAL PILE DEPTHS TO BE CONFIRMED ON SITE BY THE ENGINEER
  12. TEMPORARY STABILITY AND CUTS ARE THE RESPONSIBILITY OF THE CONTRACTOR
- 13. ALL TIMBER SURFACES EXPOSED BY CUTTING, DRILLING ETC. SHALL BE TREATED WITH AN APPROPRIATE TIMBER PRESERVATIVE E.G. COPPER NAPTHENATE BASED BRUSH ON PRESERVATIVE. ALL BOLTS AND BOLT HOLES SHALL BE LIBERALLY COATED WITH CORROSION INHIBITING GREASE BEFORE FIXING.
- MOISTURE CONTENT OF TIMBER (INCL. PILES, BALUSTERS ETC.) USED AT THE TIME OF PLACING SHALL BE LESS THAN 20%. THIS MAY REQUIRE THE CONTRACTOR TO

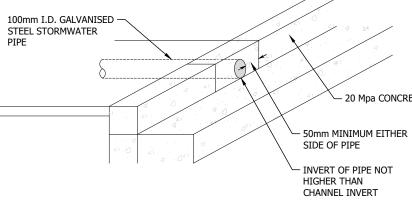


PROPOSED STORMWATER OUTLET IN KERB




MAXIMUM RETAINING HEIGHT (m)	POLE DIAMETER @ GND.LEVEL D (mm)	PILE DEPTH L (m)	PILE DIAMETER d (m)	POLE SPACING S (m)	MAX SLOPE BEHIND WALL (degrees)	RETAINING PLANKS	
0 - 2.5	275 H5 MD SED	4.0 (1.6m INTO ROCK)	0.5	1.3	10°	0-1.0m RH - 1xLAYER 200x50 1.0-2.5m RH - 2xLAYER 200x50	


## TO ASSIST WITH POLE ORDERING (REFER ALSO TO NOTES)

MAXIMUM RETAINING HEIGHT (m)	SMALL END DIAMETER SED (mm)	POLE LENGTH L (MIN.) (m)
0 - 2.5	275 H5 MD SED	6.5

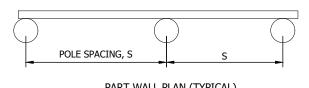

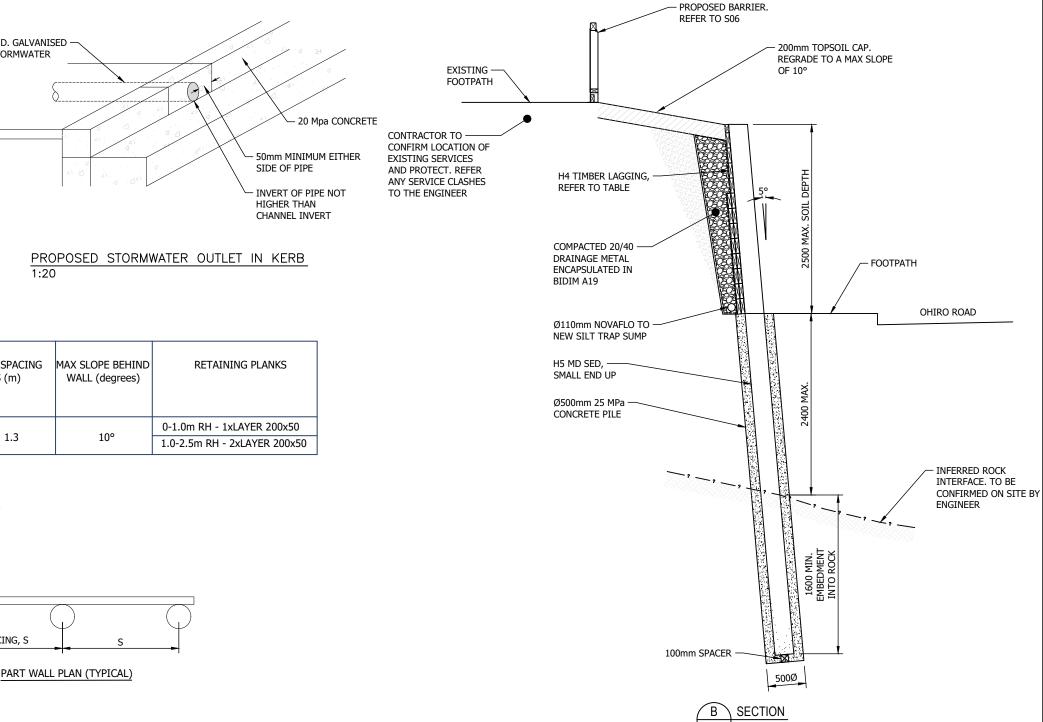



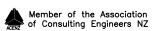

Box 13 273 Johnsonville Wellington Phone (04) 478 3929

## NOTES:

- ALL CONSTRUCTION SHALL BE IN ACCORDANCE WITH NZS 3604:2011, THE NZBC AND THE WELLINGTON CITY COUNCIL
- ALL DIMENSIONS SHALL BE CONFIRMED ON SITE PRIOR TO ORDERING MATERIALS, ALL VARIATIONS TO THE DIMENSIONS ON THE DRAWINGS SHALL BE REFERRED TO THE DESIGNER.
- CONFIRM THE LOCATIONS OF ALL SERVICES WITH SERVICE OWNERS PRIOR TO THE START OF CONSTRUCTION.

				Jo
				Jo
				Cl
В	PROPOSED BARRIER	JM	28.02.24	
Α	DETAILED DESIGN	JC	13.12.23	
Rev	Revision Details	Ву	Date	

DETAILED DESIGN ob Address: BROOKLYN HILL

WELLINGTON

WELLINGTON CITY COUNCIL


**RETAINING WALL 2 OHIRO ROAD SECTION B** 

_				
	Drawn	JC	Date	13.12.23
	Designed	JM	Date	13.12.23
	Checked	JC	Date	13.12.23
	Approved	SG	Date	13.12.23


Scale: AS SHOWN @ A3

Job No	Sheet
14565	S05

Rev

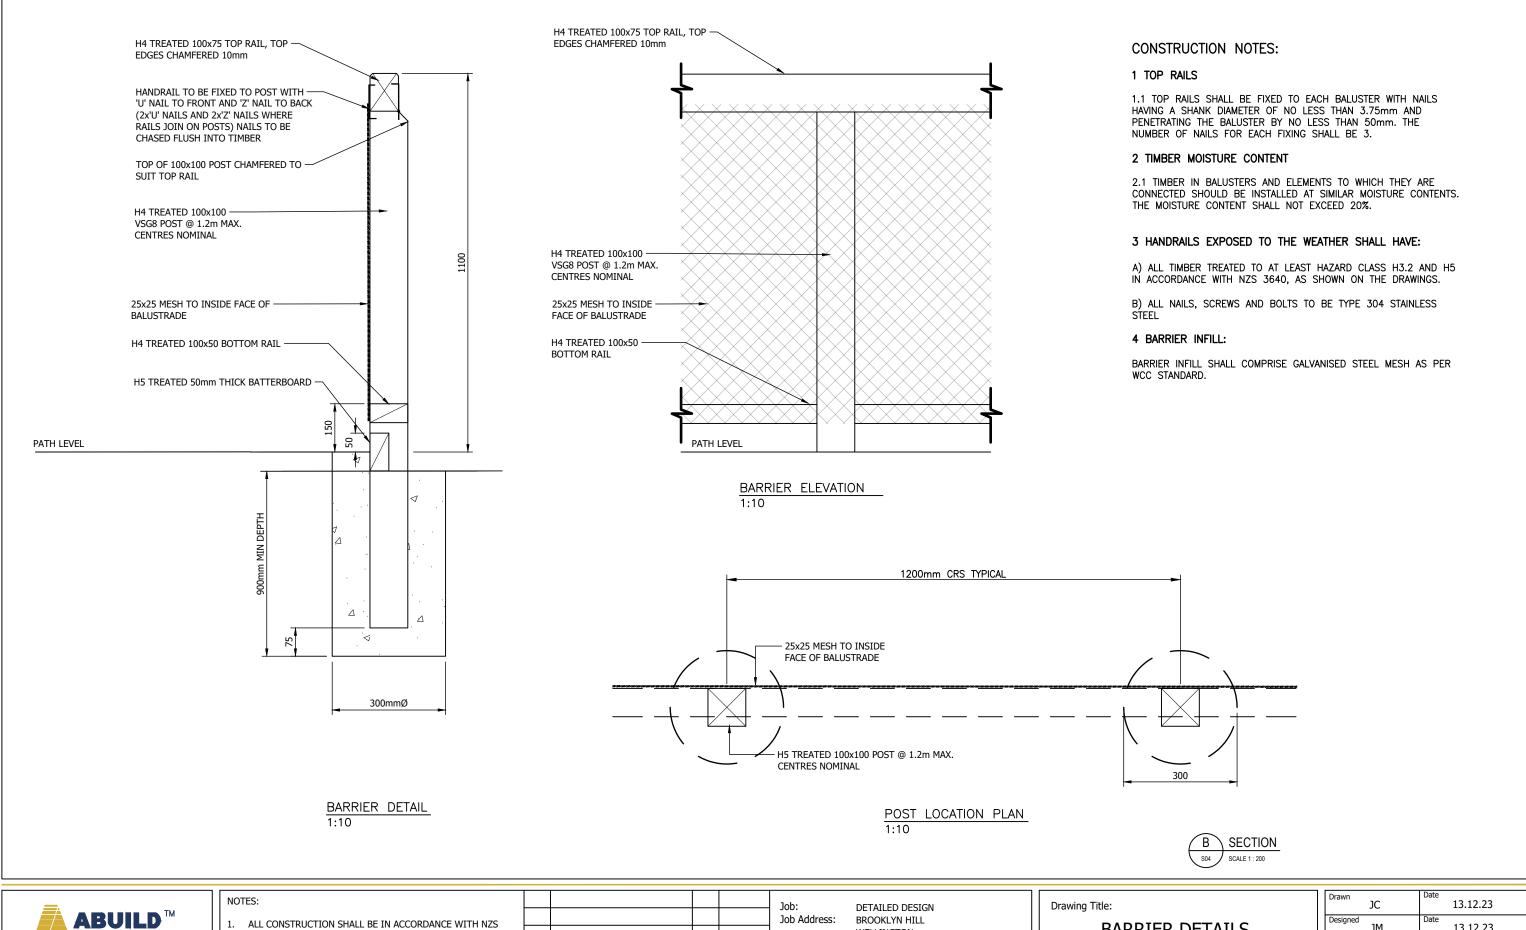



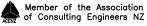

Box 13 273 Johnsonville Wellington Phone (04) 478 3929

- 3604:2011, THE NZBC AND THE WELLINGTON CITY COUNCIL
- ALL DIMENSIONS SHALL BE CONFIRMED ON SITE PRIOR TO ORDERING MATERIALS, ALL VARIATIONS TO THE DIMENSIONS ON THE DRAWINGS SHALL BE REFERRED TO THE DESIGNER.
- CONFIRM THE LOCATIONS OF ALL SERVICES WITH SERVICE OWNERS PRIOR TO THE START OF CONSTRUCTION.

				Job
				Job
				Clie
В	PROPOSED BARRIER	JM	28.02.24	
Α	DETAILED DESIGN	JC	13.12.23	
Rev	Revision Details	Ву	Date	

WELLINGTON

WELLINGTON CITY COUNCIL

## BARRIER DETAILS

Drawn	JC	Date	13.12.23
Designed	JM	Date	13.12.23
Checked	JC	Date	13.12.23
Approved	SG	Date	13.12.23

Scale: AS SHOWN @ A3

Job No Sheet 14565 S06

Rev